Greenpoint Technologies

Building 4000 Floor 2

Site Plan

Scale: N.T.S.

Deferred Submittals:

MECHANICAL PERMIT

ELECTRICAL PERMIT FIRE SPRINKLER SYSTEM

PLUMBING PERMIT

 DOCUMENTS FOR DEFERRED SUBMITTAL ITEMS SHALL BE SUBMITTED TO THE REGISTERED DESIGN PROFESSIONAL IN CHARGE (ARCHITECT/ENGINEER OF RECORD) FOR REVIEW PRIOR TO SUBMITTAL TO THE BUILDING OFFICIAL.

FIRE ALARM SYSTEM

• NO WORK SHALL PROCEED ON ANY DEFERRED SUBMITTAL ITEMS UNTIL THE DOCUMENTS HAVE BEEN APPROVED BY THE BUILDING OFFICIAL AND PERMIT OBTAINED.

Drawing Index:

I-CS.2

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Code Information:

INCL. APPENDIX B&C

CONSTRUCTION TYPE: TYPE - 1A FULLY SPRINKLERED

PROJECT ADDRESS: CARILLON POINT B4000

4100 CARILLON POINT

FLOOR 2, SUITE 4250

KIRKLAND, WA 98033

PLA-15A COMMERCIAL OCCUPANCY:

B - BUSINESS TENANT SQUARE FOOTAGE:

(area of work)

10,666 USF

APPLICABLE EDITIONS OF BUILDING CODES: 2012 INTERNATIONAL BLDG CODE (IBC).

2012 INTERNATIONAL FIRE CODE (IFC),

ENERGY CODE 2012 WASHINGTON STATE ENERGY CODE

(WSEC), WAC 51-11 2012 INTERNATIONAL MECHANICAL CODE (IMC), S

Greenpoint

Carillon Point B4000

Floor 2, Suite 4250

Kirkland, WA 98033

VA/CB

Permit/CD Issue

4100 Carillon Pt.

DESIGN DRAWN

CHECKED

2008 NATIONAL ELECTRICAL CODE (NEC) (NFPA 70) + PART 1 AND PART 3, 2009 WASHINGTON CITIES ELECTRICAL CODE WITH

APPLICABLE RW 19.28 & WAC 296-46B 2012 UNIFORM PLUMBING CODE (UPC), WAC 51-56 & 51-57 INCL. APPENDIX CHAPTERS H & L - EXCL. SECTIONS L5-L7 & "LAWN

SPRINKLER HEAD" FROM TABLE 6-4 OF ZONING CODE CITY OF KIRKLAND ZONING CODE


ACCESSIBILITY PER ICC A117.1-2009 ACCESSIBLE AND

Legal Description:

TAX PARCEL #: 172505-9058

POR GL 1 & 2 & BLKS F & G OF THE 2ND SUPL PLAT OF LK WN SH LDS TGW 2ND CL SHLDS ADJ ALL LY WLY OF W MGN LK WN BLVD-LESS POR N OF S LN OF N 1076.80 FT SD GL 1 & ITS WLY PROD — LESS POR THOF S OF LN BEG AT NXN 1902.66 FT S & PLW N LN GL 1 & W MGN LK WN BLVD TH S 03-09-13 E ALG W MGN 75 FT TO TPOB OF DESC LN TH N 88-35-53 W TO INNER HARBOR LN & TERMINUS THIS LN - LESS POR CONV BY REC 8907281497 AKA LOT B KK ALT LL #LL-91-50 REC 9104302101

Vicinity Map:

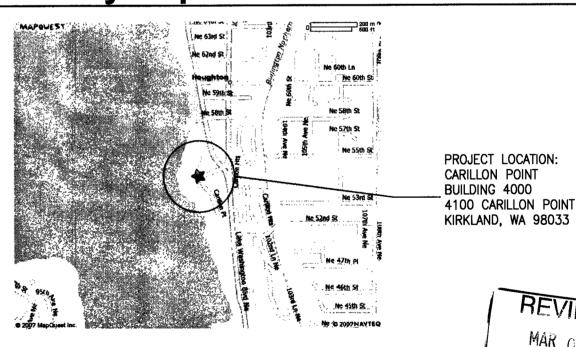

Project Team:

Property Manager:

CARILLON PROPERTIES 4100 CARILLON POINT KIRKLAND, WA 98033

TEL: 425-822-1700 FAX: 425-828-3094 KURT MILLER kurt@carillonprop.com

Architect:

JPC ARCHITECTS, PLLC 909 112TH AVE NE SUITE 206 BELLEVUE, WA 98004 (425) 641-9200

CHRISTINE BENDA ChristineB@jpcarchitects.com
AMY NICHOLS AmyN@jpcarchitects.com


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CITY OF KIRKLAND

General Contractor:

Cover Sheet & Site Plan

1-0.0

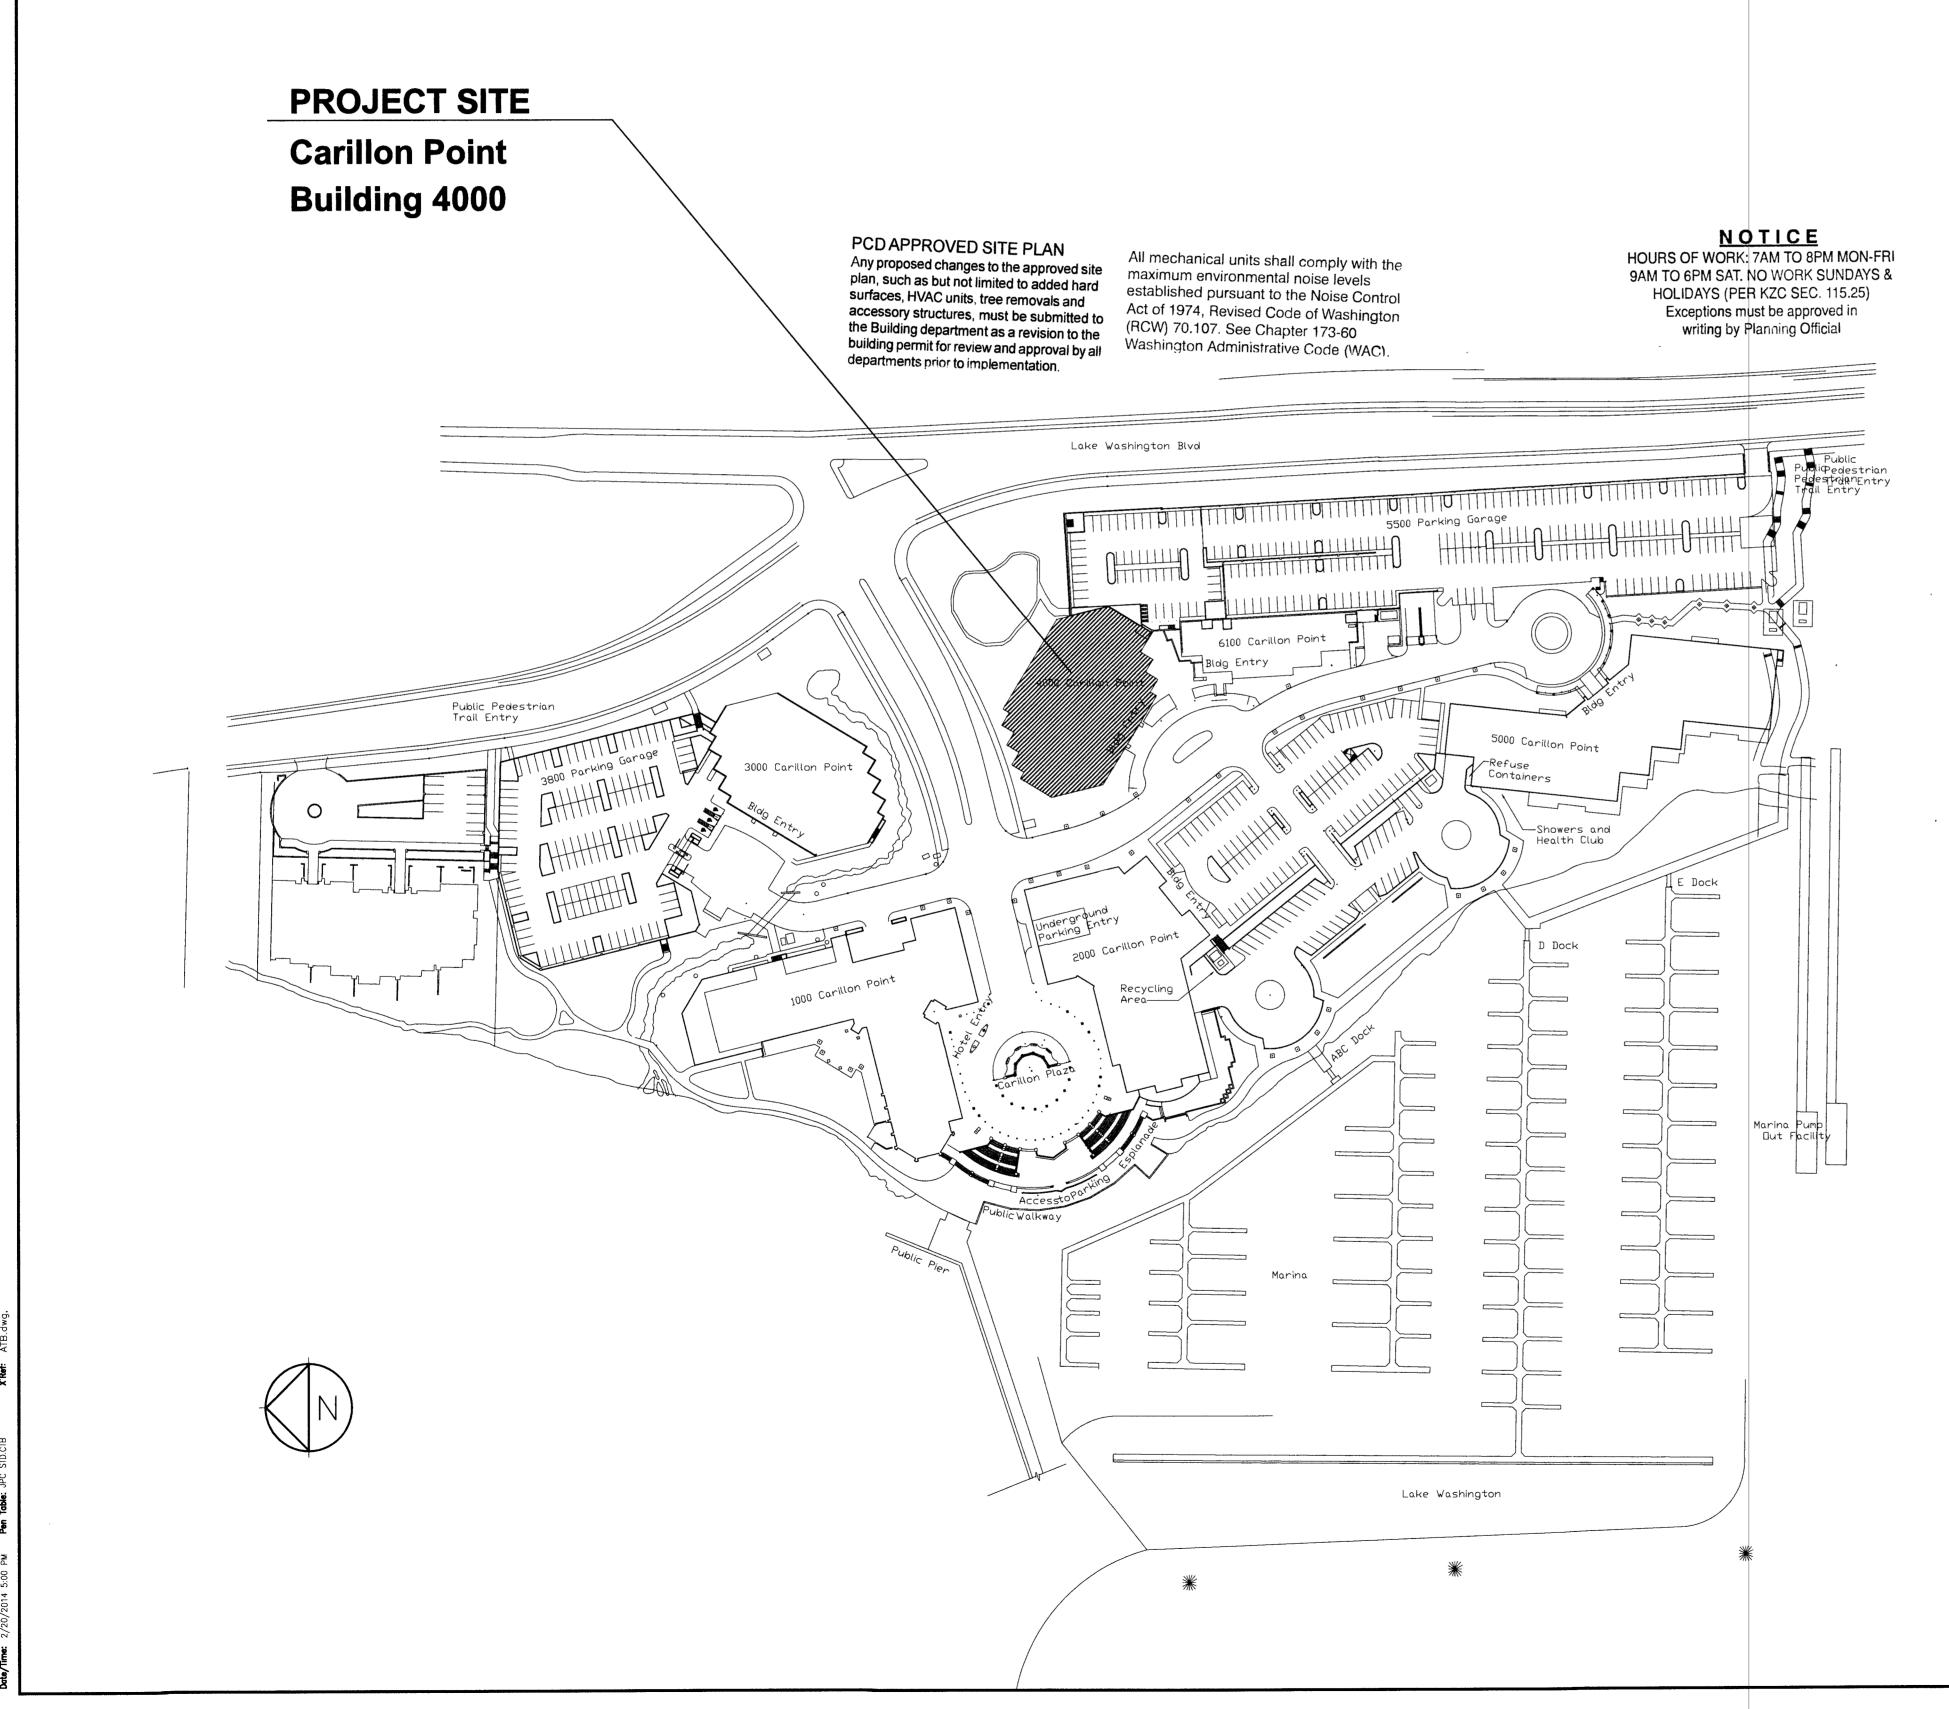


- EXISTING SHELL AND CORE CONSTRUCTION. ALL WORK IS TO BE COMPATIBLE WITH
- ALL WORK SHALL CONFORM TO APPLICABLE CURRENT FEDERAL, STATE AND LOCAL CODES. THE CONTRACTOR IS TO PROVIDE FOR ALL REQUIRED NOTIFICATION OF AND COORDINATION WITH CITY AND STATE AGENCIES, AND PROVIDE REQUIRED PERMITS. ALL TESTS AND INSPECTIONS ASSOCIATED WITH OBTAINING APPROVALS TO PROCEED WITH
- THE INTENT OF THE CONTRACT DOCUMENTS IS TO INCLUDE ALL LABOR AND MATERIALS, EQUIPMENT AND TRANSPORTATION NECESSARY OR REASONABLY INFERABLE AS BEING NECESSARY FOR THE EXECUTION OF THE WORK. BY SUBMITTING A PROPOSAL, THE CONTRACTOR REPRESENTS THAT THOROUGH EXAMINATION OF THE SITE AND ALL EXISTING CONDITIONS AND LIMITATIONS HAVE BEEN MADE AND THAT THE CONTRACT DOCUMENTS HAVE BEEN EXAMINED IN COMPLETE DETAIL, AND THAT IT IS DETERMINED BEYOND DOUBT THAT THE DRAWINGS, SPECIFICATIONS AND EXISTING CONDITIONS ARE SUFFICIENT, ADEQUATE AND SATISFACTORY FOR CONSTRUCTION OF THE WORK. WHERE MINOR ADJUSTMENTS TO THE WORK ARE NECESSARY FOR THE PURPOSES OF FABRICATION AND INSTALLATION OF ITEMS, OR RESOLUTIONS OF CONFLICTS BETWEEN ITEMS, WITHIN THE ADJUSTMENTS AFFECT FUNCTIONAL OR AESTHETIC DESIGN OF THE WORK, THEY SHALL
- THE CONTRACTOR SHALL COORDINATE ALL OPERATIONS WITH THE OWNER. INCLUDING AREA FOR WORK, MATERIALS STORAGE, AND ACCESS TO AND FROM THE WORK, SPECIAL CONDITIONS OR NOISY WORK, TIMING OF WORK AND INTERRUPTION OF MECHANICAL AND ELECTRICAL SERVICES. NOISY OR DISRUPTIVE WORK SHALL BE SCHEDULED AT LEAST

- CONTRACTOR SHALL SUBMIT SAMPLES OF ALL FINISHES OF SUCH SIZE AND NUMBER THAT THEY REPRESENT A REASONABLE DISTRIBUTION OF COLOR RANGES AND PATTERN PRIOR TO INSTALLATION FOR ARCHITECT'S APPROVAL. CONTRACTOR SHALL PROVIDE SHOP DRAWINGS AND PRODUCT DATA FOR ARCHITECT'S APPROVAL ON ALL SPECIAL
- ARCHITECT OF ANY DISCREPANCIES. CONTRACTOR IS NOT TO SCALE OFF DRAWINGS. CONTRACTOR SHALL PROVIDE 18-GAUGE SHEET METAL BACKING IN PARTITIONS FOR ALL
- CONTRACTOR SHALL NOTIFY ARCHITECT OF ANY CONDITIONS THAT DO NOT MEET THIS
- ALL MATERIALS INDICATED TO MATCH EXISTING SHALL DO SO WITH RESPECT TO SIZE, SHAPE, COLOR, TEXTURE, PATTERN, QUALITY AND METHOD OF INSTALLATION INSOFAR
- 12. ALL FIREPROOFING DISTURBED DURING CONSTRUCTION SHALL BE REPLACED TO MATCH ORIGINAL FIRE PROTECTION LEVELS. (OBTAIN REQUIRED APPROVALS AND TESTING).
- PROTECT ALL PERSONNEL, PASSERSBY OR VISITORS TO THE SITE FROM HARM AND INSTALLED DURING CONSTRUCTION. CAREFULLY MAINTAIN AND PROTECT MONUMENTS. BENCH MARKS AND THEIR REFERENCE POINT FROM BEING DESTROYED OR DISTURBED;
- 14. EXISTING WORK DAMAGED AS A RESULT OF WORK DONE UNDER THIS CONTRACT SHALL BE REPAIRED TO ORIGINAL CONDITION AND FINISHED TO MATCH ADJACENT FINISHES, SUBJECT TO ARCHITECT'S APPROVAL, AND AT NO ADDITIONAL COST TO OWNER. ALL REPLACEMENT MATERIALS REQUIRED TO MATCH EXISTING MATERIALS SHALL DO SO WITH INSTALLATION INSOFAR AS PRACTICABLE, AND SHALL BE APPROVED BY THE ARCHITECT
- REMOVED DURING CONSTRUCTION SHALL BE RESTORED AND REPLACED UNLESS NOTED OTHERWISE. FIRE/LIFE SAFETY SYSTEMS TO BE MAINTAINED DURING CONSTRUCTION.
- OPENING OF SOME EXISTING WALLS, CEILINGS OR FLOOR CAVITIES. THE CONTRACTOR SHALL BE RESPONSIBLE FOR THE REPAIR OF THESE OPENINGS TO MATCH EXISTING, EXCEPT WHERE NOTED OTHERWISE. FILL ALL HOLES AND VOIDS IN FLOORS, WALLS AND CEILINGS WHICH RESULT FROM INSTALLATION OF WORK, AND REMOVAL OF EXISTING MATERIALS AND EQUIPMENT REQUIRED BY THIS CONTRACT. PATCHED AREAS SHALL MATCH THE MATERIALS, FINISHES, AND LEVELS ADJACENT, OR SHALL BE PUT IN THE
- OPENINGS REQUIRED FOR NEW WORK THAT PENETRATES EXISTING STRUCTURE SHALL BE COORDINATED WITH OWNER PRIOR TO COMMENCING THE WORK. ANY OPENING OVER 2 IN DIAMETER SHALL BE REVIEWED AND APPROVED BY OWNER. THROUGH CONCRETE SLABS OR WALLS, OR MASONRY WALLS, ALL ROUND HOLES SHALL BE CORE DRILLED CARBIDE-TIPPED DRILLS FOR GYPSUM WALLBOARD PARTITIONS. KEEP OVERCUTTING TO A MINIMUM. MAINTAIN CONTINUITY AND INTEGRITY OF FIRE SEPARATION AT ALL TIMES. GROUT AROUND CONDUITS PASSING THROUGH CONCRETE WALLS AND FLOORS AND
- 18. CONTRACTOR SHALL PROVIDE FLOOR LEVELING AS MAY BE REQUIRED AT SLIDING DOORS,
- 19. MATERIALS, ARTICLES, DEVICES AND PRODUCTS ARE SPECIFIED IN THE DOCUMENTS BY LISTING ACCEPTABLE MANUFACTURERS OR PRODUCTS, BY REQUIRING COMPLIANCE WITH REFERENCE STANDARDS OR BY PERFORMANCE SPECIFICATIONS SELECT ANY PRODUCT SPECIFIED, SUBMIT REQUIRED SUBMITTALS, PROVIDING COMPLETE BACK-UP INFORMATION FOR PURPOSES OF EVALUATION. WHERE BUILDING STANDARD ITEMS ARE CALLED FOR,
- LOCAL FIRE CODE. PROVIDE FOR ALL REQUIRED SHOP DRAWINGS AND APPROVALS.
- ARCHITECTURAL DRAWINGS, ARE FOR LOCATION INFORMATION ONLY. MECHANICAL AND ELECTRICAL TO BE DESIGNED BY OTHERS. ALL CIRCUITING COORDINATION TO BE BY
- CABINETS, PLUMBING AND PLUMBING EQUIPMENT.
- 23. ANY CHANGE IN LIGHT FIXTURE PLACEMENT DUE TO INTERFERENCE OF MECHANICAL OR STRUCTURAL COMPONENTS MUST BE APPROVED BY THE ARCHITECT
- 24. ALL PERMITS INCLUDING FIRE, MECHANICAL, AND ELECTRICAL TO BE FILED SEPARATELY.

WOOD

WITHOUT WEIGHT

- ALL GYPSUM BOARD PARTITIONS SHALL BE TAPED, SPACKLED AND SANDED SMOOTH WITH NO VISIBLE JOINTS. PATCH AND REPAIR SURFACES TO MATCH ADJACENT OR ADJOINING SURFACES WHERE REQUIRED. ALL SURFACES SHALL BE ALIGNED.
- 26. MODIFY EXISTING SUBSTRATE AS REQUIRED TO RECEIVE NEW FLOORING MATERIALS, THUS PREVENTING NOTICEABLE LUMPS OR DEPRESSIONS.
- 27. ALL WORK SHALL BE ERECTED AND INSTALLED PLUMB, LEVEL, SQUARE AND TRUE.
- 28. REFER TO MILLWORK SHOP DRAWINGS FOR SPECIFIC DETAILS OF COORDINATION BETWEEN DRYWALL/MILLWORK CONDITIONS.
- 29. ALL GLASS SHALL BE CLEAR TEMPERED GLASS, UNLESS OTHERWISE NOTED. GLAZING TONG MARKS SHALL NOT BE VISIBLE. CLEAN AND POLISH ALL GLASS PRIOR TO PROJECT DELIVERY.
- 30. ALL MILLWORK TO BE FASTENED TO THE PARTITION. PROVIDE NON-COMBUSTIBLE BLOCKING FOR ALL MILLWORK NOT SUPPORTED BY FLOOR OR ABOVE 4'-0" HT. ALL CONCEALED LUMBER & BLOCKING TO BE FIRE TREATED.
- 31. CONTRACTOR TO PROVIDE SHOP DRAWINGS FOR: HVAC, CARPET SEAMING, LIGHTING, CASEWORK.
- 32. MOISTURE TEST REQUIRED FOR ALL ON GRADE SLAB CONDITIONS DURING THE CONSTRUCTION ESTIMATING/BUDGETING PROCESS THE GENERAL CONTRACTOR SHALL BE RESPONSIBLE FOR OBTAINING FROM THE BUILDING OWNER DOCUMENTATION AS TO THE VAPOR EMISSIONS RATE (MOISTURE TEST) FOR ALL "ON GRADE SLAB CONDITIONS". THIS INFORMATION SHOULD THEN BE IMMEDIATELY SHARED BETWEEN THE ARCHITECT, THE ARCHITECTS' SELECTED FLOORING REPRESENTATIVE(S), AND FLOORING SUB-CONTRACTOR FOR REVIEW AND APPROVAL OF APPLICABLE MATERIALS AND ANCILLARY INSTALLATION/FINISH PRODUCTS. IF NO MOISTURE TEST CAN BE FURNISHED OR IF FINDING ARE IN QUESTION THE GENERAL CONTRACTOR SHALL PERFORM THE FOLLOWING
- A. PROVIDE (3) CALCIUM CHLORIDE MOISTURE TESTS FOR THE FIRST THOUSAND SQUARE FEET AND (1) TEST FOR EVERY ONE THOUSAND SQUARE FEET THEREAFTER AT ALL FLOORS WITHIN SCOPE OF WORK. THE CALCIUM CHLORIDE TEST SHALL BE CONDUCTED IN ACCORDANCE WITH THE LATEST EDITION OF ASTM F 1869 "STANDARD TEST METHOD" FOR MEASURING VAPOR EMISSIONS RATE OF CONCRETE SUN-FLOOR USING ANHYDROUS CALCIUM CHLORIDE. PROVIDE A WRITTEN REPORT OF FINDINGS TO THE ARCHITECT AS NOTED ABOVE.
- B. PROVIDE A PH PENCIL TEST AT ALL FLOORS WITHIN SCOPE OF WORK. PROVIDE A WRITTEN REPORT OF FINDINGS TO THE ARCHITECT AS NOTED ABOVE.
- IF REQUIRED BY THE CALCIUM CHLORIDE TEST, A WATERPROOF MEMBRANE SHALL BE APPLIED TO ALL FLOORS WITHIN THE SCOPE OF WORK. THE WATERPROOF MEMBRANE(S) SHALL BE APPROPRIATED FOR EACH FINISH FLOORING APPLICATION AS SPECIFIED BY THE SPECIFIC FLOORING MANUFACTURER VIA THE ARCHITECT. A LICENSED INSTALLER SHALL BE UTILIZED FOR INSTALLATION/APPLICATION OF EACH SPECIFIC MEMBRANE (AS APPLICABLE TO THE FINISH FLOORING PRODUCT) AND A WRITTEN WARRANTY SHALL BE PROVIDED DOCUMENTING STRICT CONFORMANCE TO THE SPECIFIED MANUFACTURES INSTALLATION REQUIREMENTS TO ENSURE AND UPHOLD ALL PERFORMANCE AND LIFE CYCLE GUARANTEES.
- 33. CONCRETE SLAB ON GRADE REPAIR MINOR SCOPE (100 SQUARE FEET OR LESS)
- WHERE CONCRETE SLAB ON GRADE INFILL AND TRENCHING MUST OCCUR; CONDUCT THE APPROPRIATE UNDER SLAB INVESTIGATION (VIA SONO-GRAPH AND/OR X-RAY) TO LOCATE EXISTING UTILITIES OR OTHER OBSTRUCTIONS THAT SHOULD NOT BE DAMAGED. SAW CUT SLAB AT SUBJECT AREA(S) AND PULL BACK THE EXISTING VAPOR BARRIER (IF PRESENT) AND PROTECT FOR FUTURE RE-INSTALLATION. EXECUTE THE NECESSARY UNDER SLAB WORK (INCLUDING EXCAVATION), BACKFILL AND RE-COMPACT THE SUBJECT AREA WITH THE PREVIOUSLY HELD MATERIALS (IF THE EXCAVATED MATERIALS ARE NOT SUITABLE FOR RE-INSTALLATION, DISCARD AND PROVIDE NEW FREE DRAINING GRANULAR MATERIAL). RE-COMPACT FILL SOIL TO AT LEAST 95% OF THE MAXIMUM DRY DENSITY (MDD) OBTAINED IN GENERAL ACCORDANCE WITH THE ASTM D 1557 TEST PROCEDURE. RE-INSTALL THE EXISTING VAPOR BARRIER AND BIND SEAMS WITH MINIMUM 3" WIDE PRESSURE SENSITIVE TAPE TO ENSURE AN AIR/MOISTURE RESISTANT BOND. ATTACH NEW INFILL TO EXISTING CONCRETE SLAB WITH 18 INCH LONG #4 REBAR AT 24 INCHES ON CENTER EMBEDDED 8 INCHES INTO THE EXISTING CONCRETE SLAB WITH HILTI HY-150 ADHESIVE (OR SIMPSON SET ADHESIVE). REINFORCEMENT SHALL BE INSTALLED PER ADHESIVE MANUFACTURER'S RECOMMENDATIONS. PROVIDE W2 X W2 X 6 X 6 WELDED WIRE FABRIC WITHIN SUBJECT AREA(S), INFILL SLAB TO MATCH THICKNESS OF ADJACENT SURFACE(S) (BUT NOT BE LESS THAN FOUR INCHES THICK) AND #4 DOWELS SHALL BE CENTERED IN SLAB. THE CONCRETE SHALL HAVE A MINIMUM 28 DAY COMPRESSIVE STRENGTH OF 3000 PSI WITH A MAXIMUM WATER CEMENT RATION OF 0.58 AND IS TO BE PLACED LEVEL WITH ADJACENT SURFACES. LET CURE AND PROVIDE MOISTURE TESTING AS SPECIFIED ABOVE.
- IF SCOPE OF WORK INCLUDES STRUCTURAL ELEVATED SLABS CONSULT A STRUCTURAL ENGINEER. REFER TO STRUCTURAL PLANS, IF APPLICABLE, FOR ADDITIONAL SPECIFICATIONS AND REQUIREMENTS.
- CLEAN, REPAIR ANY EXISTING PERIMETER BLINDS AS REQUIRED TO BE IN A FULLY FUNCTIONING & OPERATIONAL MANNER.
- COORDINATE WITH SUB-CONTRACTORS THE LOCATIONS OF ELECTRICAL AND VOICE/DATA OUTLETS, PLUMBING AND OTHER DEVICES WITH LAYOUT AND DESIGN OF CUSTOM CASEWORK.
- 36. CASEWORK SHALL CONFORM TO A.W.I. CURRENT STANDARDS.
- EGRESS LIGHTING SHALL BE DESIGNED BY A LICENSED ELECTRICAL ENGINEER BASED ON FINAL FLOOR PLAN(S) AND THE MOST CURRENT (IN FORCE) ISSUE OF THE IBC, IEC AND LOCAL CODES/ORDINANCES. THE ENGINEER MAY USE THE ARCHITECTS EGRESS MAPS (COMMON PATH OF TRAVEL/EXIT TRAVEL DISTANCE) AS STARTING POINT FOR A BASIS OF DESIGN. HOWEVER, IT SHALL REMAIN THE SOLE RESPONSIBILITY OF THE ENGINEER TO COMPLETE A SCOPE OF WORK THAT ADDRESSES ALL EGRESS LIGHTING I.E.; ROOMS, SPECIALIZED SPACES, PATHWAYS, ETC. PER THE AFOREMENTIONED CODES. FINAL EGRESS LIGHTING QUANTITIES AND LOCATIONS SHALL BE DETERMINED BY BUILDING AND FIRE INSPECTOR'S FIELD PLACEMENT DETERMINATION.

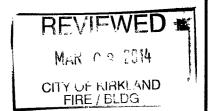


Symbol Legend:

2306 ROOM NUMBER REFERENCE

2306 DOOR NUMBER REFERENCE.

(I-10.3) INTERIOR ELEVATION SYMBOL

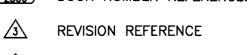

JOB NORTH

REFERENCE KEY (REFER TO SHEET/KEY NOTES

DETAIL REFERENCE BUBBLE

 \triangleleft

Carillon Point B4000 Floor 2, Suite 4250 4100 Carillon Pt. Kirkland, WA 98033

DESIGN JPC DRAWN **VA/CB** CHECKED 13-0944



Permit/CD Issue

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General Notes & Symbols



02.21.14 Permit/CD Issue

Exit Plan and Codes Summary

Floor 2, Suite 4250 4100 Carillon Pt. Kirkland, WA 98033

> JPC VA/CB AN 13-0944



Permit/CD Issue

Demolition Plan

1-1.2

Floor Plan Key Notes:

FREE-STANDING (ELECTRIFIED) WORKSTATIONS, (T.F.T.I.).

ANCILLARY FURNITURE, FIXTURES AND EQUIPMENT, (T.F.T.I.). INCLUDING, BUT NOT LIMITED TO FILE CABINETS, TABLES, CHAIRS. PROVIDE AND INSTALL SALVAGED CARD READER AT 34"AFF - FAIL

SAFE AT EGRESS DOORS: DOOR LOCKS MUST AUTOMATICALLY

RELEASE WITH LOSS OF POWER TO THE DOOR LOCK OR RELEASING DEVICE. DOORS MUST REMAIN UNLOCKED UNTIL THE POWER SUPPLY

IS RESTORED. DOOR LOCKS MUST AUTOMATICALLY RELEASE WITH LOSS OF PRIMARY POWER TO THE FIRE ALARM CONTROL PANEL. AN

APPROVED SMOKE DETECTOR SHALL BE INSTALLED WITHIN THE

NON-EGRESS DOORS WITH CARD READERS TO BE FAIL-SECURE. PROVIDE AND INSTALL POWER AND ELECTRONIC LOCKING HARDWARE

ALL OUTLETS AT BISTRO #203 TO BE ON SEPARATE CIRCUITS FROM

PROVIDE STAINLESS STEEL COVER PLATES AT OUTLET AND LIGHT

NEW CEILING HEIGHT FRAMELESS GLASS PARTITION ON METAL

REFER TO FINISH PLAN FOR ADDITIONAL INFORMATION.

LOCATION WITH TENANT'S FURNITURE VENDOR.

TO APPLIANCE LEGEND ON SHEET I-8.1.

(19) NOT USED.

PROVIDE 96"W X 48"H WRITABLE GLASS BOARD WITH CLEAR

FURR OUT EXISTING COLUMNS AS REQUIRED TO ACCOMMODATE

18) PROVIDE FILTERED WATER LINES AND DRAINS (AS REQUIRED). REFER

POWER AND VOICE/DATA FEEDS/OUTLETS AS SHOWN.

ANODIZED ALUMINUM PEN TRAY. CENTER ON WALL WHERE INDICATED ON FLOOR PLAN IN CONFERENCE ROOMS AND MOUNT BOTTOM OF BOARD @ 2'-10" AFF. SUBMIT CUT-SHEET TO ARCHITECT FOR APPROVAL. MFR: CLARUS GLASSBOARD DEPTH; COLOR: WHITE PROVIDE LEGRAND WIREMOLD 6 AT POKE-THRU DEVICE UNDER TABLE AT ALL CONFERENCE ROOMS, COLOR TBD. VERIFY CONFIGURATION REQUIRED FOR PLUG-IN OR HARD-WIRE. VERIFY EXACT CORE

PROVIDE ₹" FIRE-TREATED PLYWOOD BACKBOARD AT I.T. SWITCH. PAINT TO MATCH WALLS. CONFIRM SIZE AND LOCATION FROM TENANT REFER TO TENANT'S LAYOUT FOR SPECIFIC ROOM REQUIREMENTS. 4) INSTALL DECORATIVE GLASS FILM ON ALL INTERIOR RELIGHTS (GF-1)

PROVIDE CHASE TO RUN CONDUIT TO GREENPOINT SERVER ROOM ON FLOOR 6. VERIFY EXACT CONDUIT SIZE AND LOCATION WITH TENANT. PROVIDE BREAKOUT COST AT ALL EXISTING DOOR LOCATIONS TO REMAIN: REPLACE WOOD DOOR, JAMB AND TRIM TO MATCH BUILDING STANDARD. REINSTALL EXISTING HARDWARE. EXISTING RELIGHTS TO

REFER TO 1-8.1 FOR APPLIANCE SCHEDULE IN BISTRO 206.

SWITCH LOCATIONS IN BISTRO #203.

CHANNELS. REFER TO DETAIL 7/I-9.1.

ELEVATOR LOBBY IN ACCORDANCE WITH THE MANUFACTURER'S LISTING INSTRUCTIONS AND SHALL INITIATE A GENERAL FIRE ALARM WHEN ACTIVATED. DOOR LOCKS MUST AUTOMATICALLY RELEASE ON ACTIVATION OF THE BUILDING ALARM SYSTEM (SPRINKLER HEAD, SMOKE/HEAT DETECTOR OR PULL STATION ACTUATION). DOORS MUST REMAIN UNLOCKED UNTIL THE FIRE ALARM SYSTEM IS MANUALLY

OPERATIONAL WORKSTATION SYSTEM.

ELECTRICAL/LOW VOLTAGE DESIGN-BUILD CONTRACTORS TO MAKE ALL NECESSARY CONNECTIONS TO INSURE A FULLY FUNCTIONING AND

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20) EACH PRIVATE OFFICE TO HAVE MINIMUM OF (2)120V DUPLEX OUTLETS AND (2)DATA/VOICE JACKS. INSTALL NEW AS REQUIRED AND VERIFY NEW LOCATIONS WITH ARCHITECT. NOTE: EXISTING POWER SHOWN IN PRIVATE OFFICES AND CONFERENCE ROOMS HAS NOT BEEN FIELD VERIFIED.

REVI

PROVIDE (3)20A-120V AND (1)60A-208V 3-WIRE SINGLE PHASE DEDICATED ELECTRICAL OUTLETS AS SHOWN ON FLOOR PLAN IN IT SWITCH #202. VERIFY EXACT POWER AND COOLING REQUIREMENTS

RECESSED GWB NICHE WITH LIGHT COVE CENTERED IN PARTITION FOR SIGNAGE (PROVIDED BY AND INSTALLED BY TENANT). FURR OUT EXISTING WALL. REFER TO DETAIL 10/I-9.1 FOR ADDITIONAL INFORMATION.

23 RELOCATE THERMOSTATS ABOVE NEW SWITCH LOCATION.

Symbols Legend:

F.E.C. BUILDING STANDARD FIRE EXTINGUISHER CABINET

- DUPLEX RECEPTACLE
- DEDICATED DUPLEX RECEPTACLE
- GFI DUPLEX RECEPTACLE
- FOURPLEX RECEPTACLE
- DEDICATED FOURPLEX RECEPTACLE
- CORE DRILL

REFER TO DETAIL 7/I-9.1

APPROPRIATE METAL STUD WIDTH TO ACCOMMODATE SIZING

AT LOCATIONS REQUIRED FOR ARCHITECTURAL FEATURES AND/OR

"IN-WALL" ELECTRICAL/MECHANICAL/PLUMBING SYSTEMS, PROVIDE

REQUIREMENT. CONFORM TO SPECIFIED METAL GAUGE AND SPACING

AS INDICATED BY WALL TYPE. REFER TO CONSTRUCTION LEGEND FOR

Partition Legend Notes

ADDITIONAL INFORMATION.

- J-BOX FOR TENANT PROVIDED SYSTEMS FURNITURE. PULL STRING
- (CR)— PROXIMITY CARD READER ♦ WALL TAG

NO DESIGNATION = EXISTING N = NEW

R = RELOCATED (COORDINATE WITH ARCHITECT)

Floor Plan

1-3.2



DESCRIPTION

3WAY SWITCH

BLDG STD EXIT LIGHT

CEILING GRID & TILE

EXTG BLDG STD 2x4 SUSP

EXISTING BLDG STD 2x4 FLU LIGHT FIXTURE: LUNA #FLU24B 2-T8 WW LAMPS

EXISTING BLDG STD 2x2 FLU LIGHT FIXTURE: LUNA

#FLU22B 2-T8 WW LAMPS

EXISTING FLUORESCENT

EXISTING FLUORESCENT 2X2 PARABOLIC FIXTURES

REVIEWED 3

MAR 0 3 2014

CITY OF KIRKLAND FIRE / BLDG

2X4 PARABOLIC FIXTURES


Greenpoint Carillon Point B4000

Floor 2, Suite 4250 4100 Carillon Pt. Kirkland, WA 98033

DESIGN JPC DRAWN VA/CB CHECKED AN 13-0944

Demo Reflected Ceiling Plan

1-4.2.1

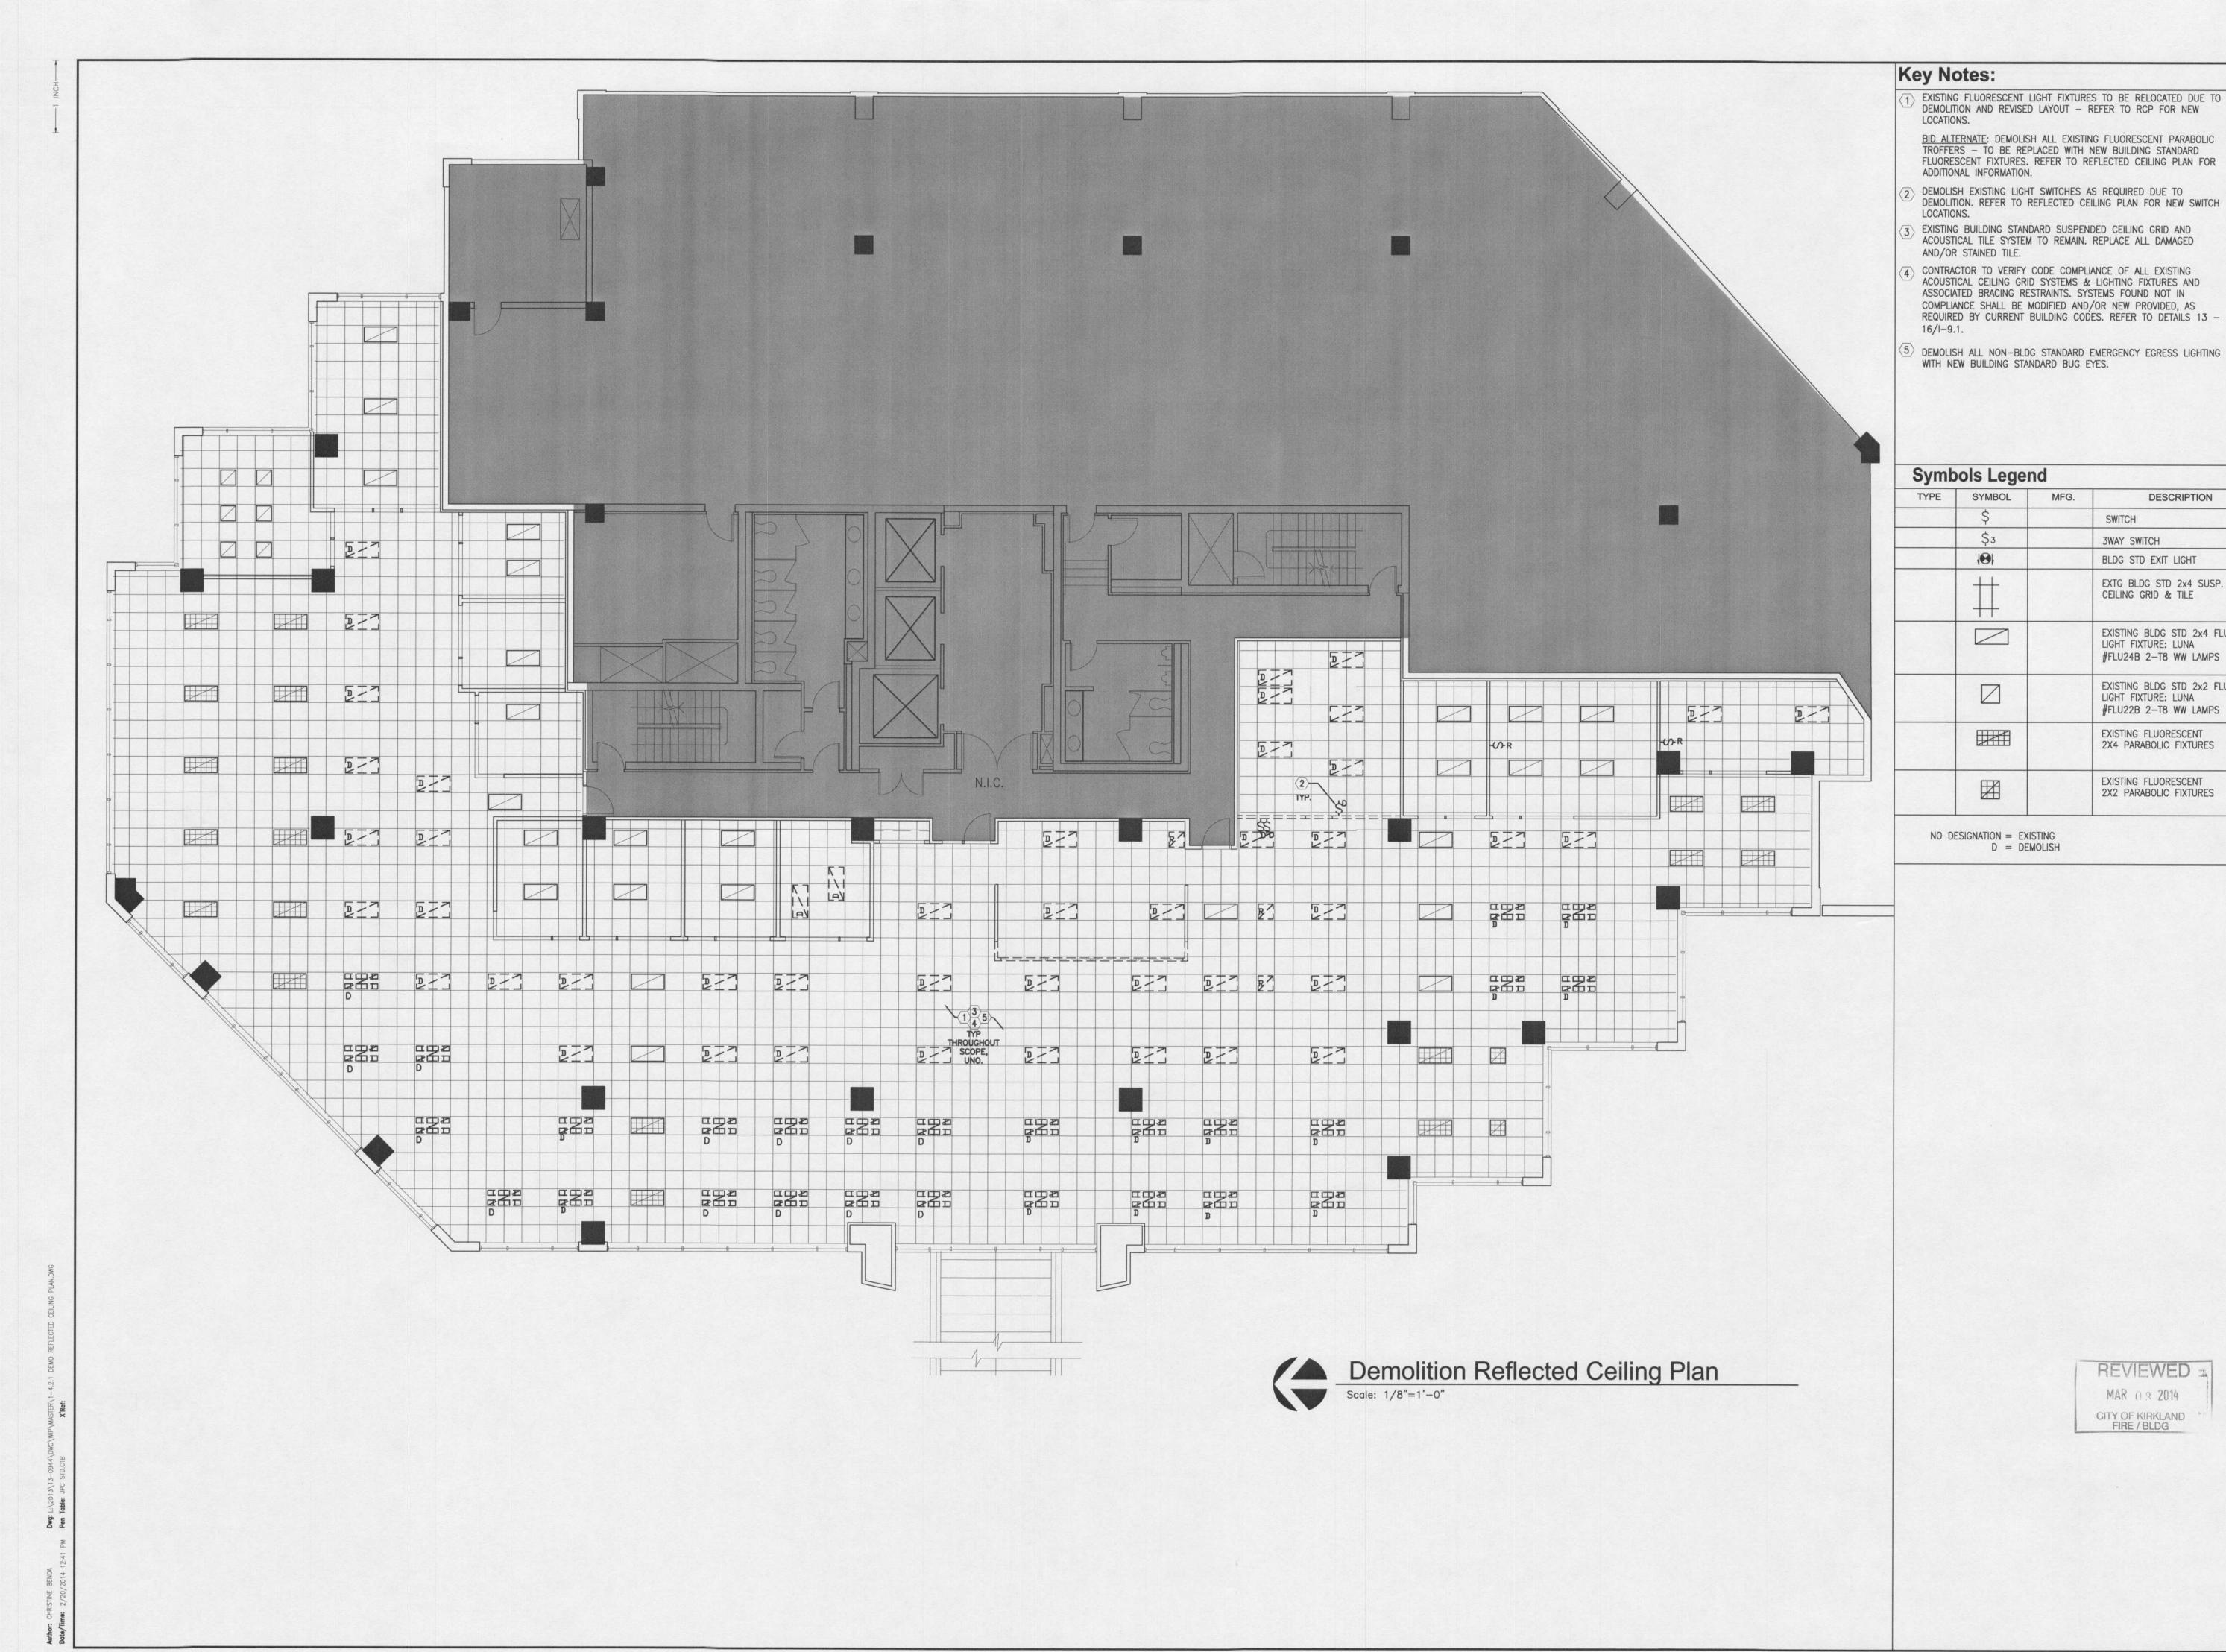

Floor 2, Suite 4250 4100 Carillon Pt. Kirkland, WA 98033

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AN

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13-0944

DESIGN DRAWN CHECKED NO.

STATE OF WASHINGTO

Permit/CD Issue

Reflected Ceiling Plan

CEILING-MOUNTED PROJECTO SCREEN. VERIFY EXACT DE LOCATION & POWER REQ'TS WITH TENANT'S A/V VENDOR

CITY

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Reflected Ceiling Plan Key Notes: MODIFY EXISTING ELECTRICAL, MECHANICAL AND LIFE SAFETY SYSTEMS AS REQUIRED BY SCOPE OF NEW WORK, MOST CURRENT ISSUE OF APPLICABLE BUILDING CODES AND DESIGN/CONSTRUCTION STANDARDS FOR CARILLON POINT B4000 INCLUDING, BUT NOT LIMITED TO CIRCUITING, SWITCHING, DUCTING (SUPPLIES/RETURNS), BALANCING, SPRINKLER HEAD AND/OR HORN/STROBE RELOCATION, NOTE: IT IS THE INTENT THAT ALL ABOVE-CEILING SYSTEMS BE INVESTIGATED PRIOR TO BID SUBMISSION AND THAT SAID SUBMISSION SHALL CONSTITUTE ACCEPTANCE OF THE TERMS REFERENCED BELOW WITHOUT ADDITIONAL PROJECT AND/OR TENANT COSTS. ALL ABOVE-CEILING EQUIPMENT/DEVICES THAT REQUIRE "ACCESSIBILITY" OR ARE IN DIRECT CONFLICT WITH THE ARCHITECTS' DESIRED DESIGN INTENT (ARCHITECTURAL CEILING DESIGN, LIGHTING PLACEMENT, ETC.)

SHALL BE REMOVED AND RELOCATED. IF REMOVAL AND/OR RELOCATION IS NOT PHYSICALLY POSSIBLE OR IS DEEMED

DESIGN-BUILD DOCUMENTS AND COMMENCEMENT OF

COST-SENSITIVE, A LETTER SHALL BE SUBMITTED BY EACH TRADE T THE ARCHITECT FOR REVIEW/APPROVAL PRIOR TO COMPLETION OF

CONSTRUCTION-RELATED ACTIVITIES. PROVIDE POWER & DATA/AV, AS DIRECTED BY TENANT'S A/V VENDOR, IN CEILING FOR CEILING-MOUNTED PROJECTOR AND ELECTRONIC RECESSED PROJECTOR SCREEN (VERIFY EXACT LOCATIONS AND SPECIFICATIONS WITH AV CONSULTANT). PROVIDE 1-1/2" CONDUIT BETWEEN TABLE AND CEILING-MOUNTED PROJECTOR.

- REPLACE ALL NON-BLDG STANDARD EGRESS LIGHTING WITH NEW BUILDING STANDARD BUG EYES.
- RELOCATE EXISTING TROFFERS AS REQUIRED DUE TO REVISED LAYOUT. EXISTING PARABOLIC FIXTURES THAT ARE (2) FIXTURES FROM EXTERIOR WINDOWS TO REMAIN-RELOCATE AS NECESSARY DUE TO REVISED LAYOUT - REFER TO RCP FOR REVISED LOCATIONS.

BID ALTERNATE: REMOVE ALL EXISTING FLUORESCENT PARABOLIC FIXTURES AND REPLACE WITH NEW BUILDING STANDARD FLUORESCENT FIXTURES. COORDINATE WITH PROPERTY MANAGER TO REINSTALL SALVAGED BUILDING STANDARD FIXTURES FROM T.I. WORK OCCURRING IN B5000 / FLOOR 2

PROVIDE AND INSTALL NEW PENDANT FIXTURES (F-7) IN BISTRO 206 EXACT LOCATION TO BE FIELD DETERMINED.

Symbols Legend

SYMBOL

\$3

PS

NO DESIGNATION = EXISTING

N = NEW

R = RELOCATED

MFG.

METALUX

BRUCK

TECH

LIGHTING

SWITCH

3WAY SWITCH

BLDG STD EXIT LIGHT

CEILING GRID & TILE

NEW GWB SOFFIT

2-T8 WW LAMPS

FOCAL POINT BLDG STD 2x4 FLU. LIGHT

FOCAL POINT BLDG STD 2x2 FLU. LIGHT

T8 WW LAMP

QUAD LAMPS

#Z132-MV

LEDRA G6 (7.2W)

1-T8 WW LAMP

EXTG BLDG STD 2x2 SUSP.

EXTG BLDG STD 2x2 SUSP. CEILING GRID & TILE

FIXTURE: LUNA #FLU24B-WH

FIXTURE: LUNA #FLU22B-WH

FLU. UNDER-CABINET LIGHTING

SWITCH WITH OVERHEAD LIGHT

BLDG STD RECESSED, FLU.

RECESSED DIMMABLE LED.

48" FLUORESCENT STRIP

LOW-VOLT MINI PENDANT

GLASS: CRYSTAL, FINISH:SN

CEILING-MOUNTED PROJECTOR

VERIFY EXACT LOCATION WITH

#700-OTO-MP-C-S

EXISTING FLUORESCENT

PARABOLIC FIXTURES

TENANT'S A/V VENDOR

DOWNLIGHT FIXTURE, 2-13W

CL-132-UNV-SERIES LENGTH PER PLAN;

DESCRIPTION

TYPE

F-2

F-3

F-5

F-6

ILLUMINATED EXIT LIGHT. ALL EXIT LIGHTS AND EGRESS LIGHTING LOCATIONS SHALL BE DETERMINED BY BUILDING AND FIRE INSPECTOR'S FIELD PLACEMENT DETERMINATION.

Reflected Ceiling Notes:

- COORDINATE THE WORK OF ALL TRADES INVOLVED IN THE CEILING WORK TO ENSURE CLEARANCES FOR FIXTURES, DUCTS, PIPING, CEILING SUSPENSION SYSTEM, ETC., NECESSARY TO MAINTAIN THE FINISHED CEILING HEIGHTS INDICATED ON ARCHITECT'S DRAWINGS.
- PERIMETER CEILING ANGLE, WHERE OCCURS, SHALL BE INSTALLED TIGHT TO VERTICAL SURFACES, FREE FROM CURVES, BREAKS OR OTHER IRREGULARITIES AND PAINTED TO MATCH CEILING FINISH.
- FURNISH AND INSTALL ALL ASSOCIATED TRIM AND SEISMIC BRACING AS REQUIRED.
- LIGHT FIXTURES, NEW SPRINKLERS AND OTHER CEILING ELEMENTS SHALL BE CENTERED IN THE 2'X2' SECTION OF INDIVIDUAL CEILING TILES U.N.O. (EXIST. SPRINKLERS TO REMAIN UNLESS CONFLICT WITH NEW ELEMENTS).
- PROVIDE CEILING ACCESS AS REQUIRED FOR EQUIPMENT AND SYSTEM MAINTENANCE, AND MATCH ADJACENT CEILING FINISH U.N.O.
- ALL SOFFITS AND CEILING HEIGHTS ARE DIMENSIONED FROM TOP OF FINISHED FLOOR TO BOTTOM OF FINISHED GYPSUM BOARD OR CEILING TILE AND SHALL ALLOW FOR THICKNESS OF ALL FLOOR FINISHES.

- 7. THE REFLECTED CEILING PLAN INDICATES THE LOCATION OF CEILING HEIGHTS, LIGHT TYPES, LIGHT FIXTURES, AND ASSOCIATED ITEMS.
- 8. ALL SPECIFIC INFORMATION CONCERNING INSTALLATION FOR VARIOUS ABOVE-CEILING ELEMENTS ARE TO BE DESIGN BUILD, DOCUMENTATION BY OTHERS - PERMITTED SEPARATELY.
- 9. NOTIFY ARCHITECT OF ANY CONFLICTS OF LIGHT FIXTURE LOCATIONS WITH MAIN RUNNERS, DUCTS, STRUCTURES, HVAC, AND/OR (E)CONDUIT, PRIOR TO FRAMING FOR LIGHTS. ANY DISCREPANCIES BETWEEN ARCHITECT'S CEILING GRID LOCATION & ACTUAL FIELD CONDITIONS ARE TO BE CLARIFIED WITH THE ARCHITECT PRIOR TO FRAMING.
- 10. SUBMIT GRILLE, THERMOSTAT, AND OTHER FIXTURE AND ELEMENT LAYOUTS TO THE ARCHITECT FOR REVIEW AT LEAST 2 WEEKS PRIOR TO
- 11. VERIFY FIELD CONDITIONS AND LOCATIONS OF ALL PLUMBING, MECHANICAL DUCTS, STRUCTURAL ELEMENTS AND ALL OTHER RELATED ITEMS. INSTALL NEW PLUMBING, MECHANICAL, FANS, DUCTS, CONDUITS, AND OTHER RELATED ITEMS SO AS TO NOT CONFLICT WITH ANY/ALL FIELD CONDITIONS INCLUDING LUMINAIRES.
- 12. INSTALL NEW LIGHT FIXTURES WITH PROTECTIVE FILM OR SIMILAR COVER OVER LOUVER, LENS, BAFFLE, ETC. TO AVOID FIXTURE SOILING OR DAMAGE. FIXTURES SHALL BE MAINTAINED CLEAN AND AS NEW. ALL LAMPS SHALL BE NEW AT PROJECT COMPLETION - RELAMP EXISTING FIXTURES.

1-9.1

THROUGHOUT

SCOPE,

- 13. CONTRACTOR TO VERIFY CODE COMPLIANCE OF EXISTING ACOUSTICAL CEILING GRID SYSTEMS AND ASSOCIATED SEISMIC BRACING RESTRAINTS. SYSTEMS FOUND NOT IN COMPLIANCE SHALL BE MODIFIED AND/OR NEW PROVIDED AS REQUIRED BY CURRENT BUILDING CODES (INCLUDING, BUT NOT LIMITED TO; CURRENT IBC WALL MOLDING (2" ANGLE) AND SEISMIC SEPARATION JOINTS).
- 14. CONTRACTOR TO VERIFY CODE COMPLIANCE OF ALL EXISTING LIGHTING FIXTURES AND ASSOCIATED SEISMIC BRACING RESTRAINTS. FIXTURES FOUND NOT IN COMPLIANCE SHALL BE MODIFIED AND/OR NEW PROVIDED AS REQUIRED BY CURRENT BUILDING AND/OR ENERGY COMPLIANCE CODES.
- 15. ALL EXITING LIGHTS AND EGRESS LIGHTING LOCATIONS SHALL BE DETERMINED BY BUILDING AND FIRE INSPECTOR'S FIELD PLACEMENT DETERMINATION.

OR SUPERCEDING CODE. ALL FIRE DAMPERS SHALL BE INSTALLED IN

Reflected Ceiling Plan


Scale: 1/8"=1'-0"

17. EGRESS LIGHTING SHALL BE DESIGNED BY A LICENSED ELECTRICAL ENGINEER BASED ON FINAL FLOOR PLAN(S) AND THE MOST CURRENT (IN FORCE) ISSUE OF THE IBC, IEC AND LOCAL CODES/ORDINANCES. THE ENGINEER MAY USE THE ARCHITECTS EGRESS MAPS (COMMON PATH OF TRAVEL/EXIT TRAVEL DISTANCE) AS STARTING POINT FOR A BASIS OF DESIGN. HOWEVER, IT SHALL REMAIN THE SOLE RESPONSIBILITY OF THE LIGHTING I.E.; ROOMS, SPECIALIZED SPACES, PATHWAYS, ETC. PER THE AFOREMENTIONED CODES. FINAL EGRESS LIGHTING QUANTITIES AND LOCATIONS SHALL BE DETERMINED BY BUILDING AND FIRE INSPECTOR'S

16. ALL SMOKE DAMPERS SHALL BE INSTALLED IN ACCORDANCE WITH IMC/IBC ACCORDANCE WITH IMC/IBC OR SUPERCEDING CODE.

ENGINEER TO COMPLETE A SCOPE OF WORK THAT ADDRESSES ALL EGRESS FIELD PLACEMENT DETERMINATION.

INSTALLATION.

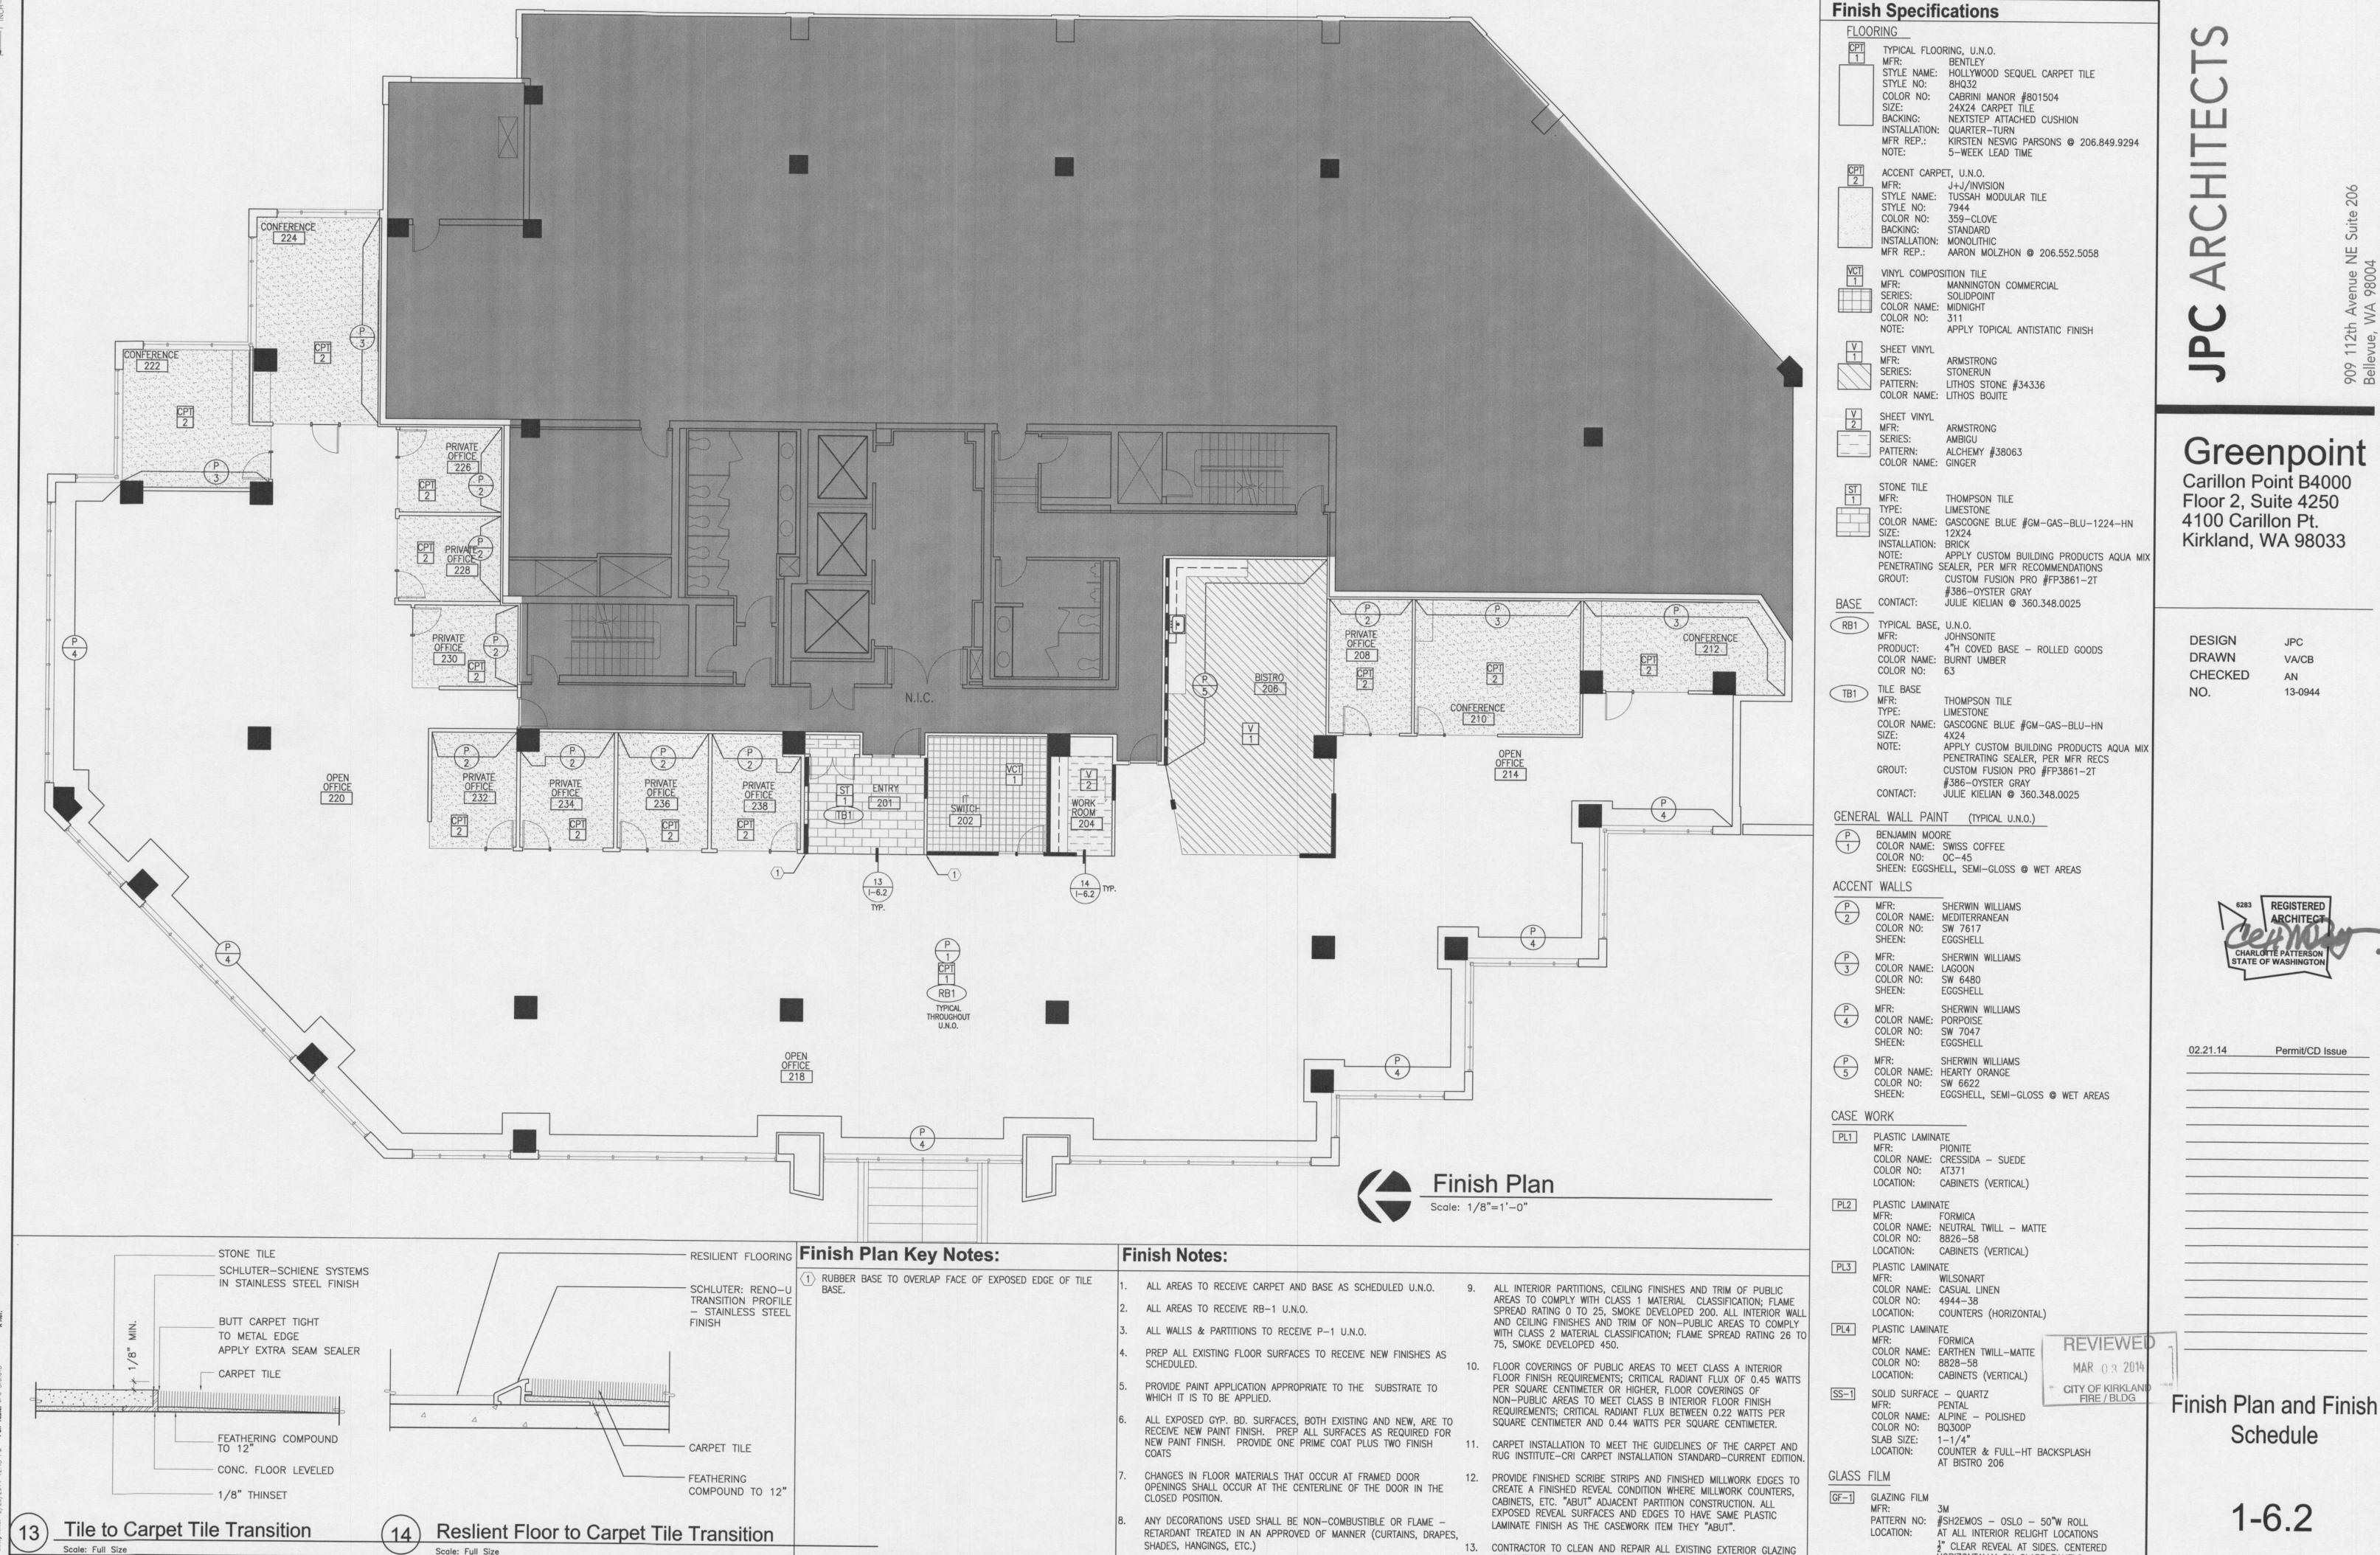


Scale: Full Size



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HORIZONTALLY ON GLASS PANELS

AND INTERIOR RELITE MINI-BLINDS WITHIN THE WORK AREA.

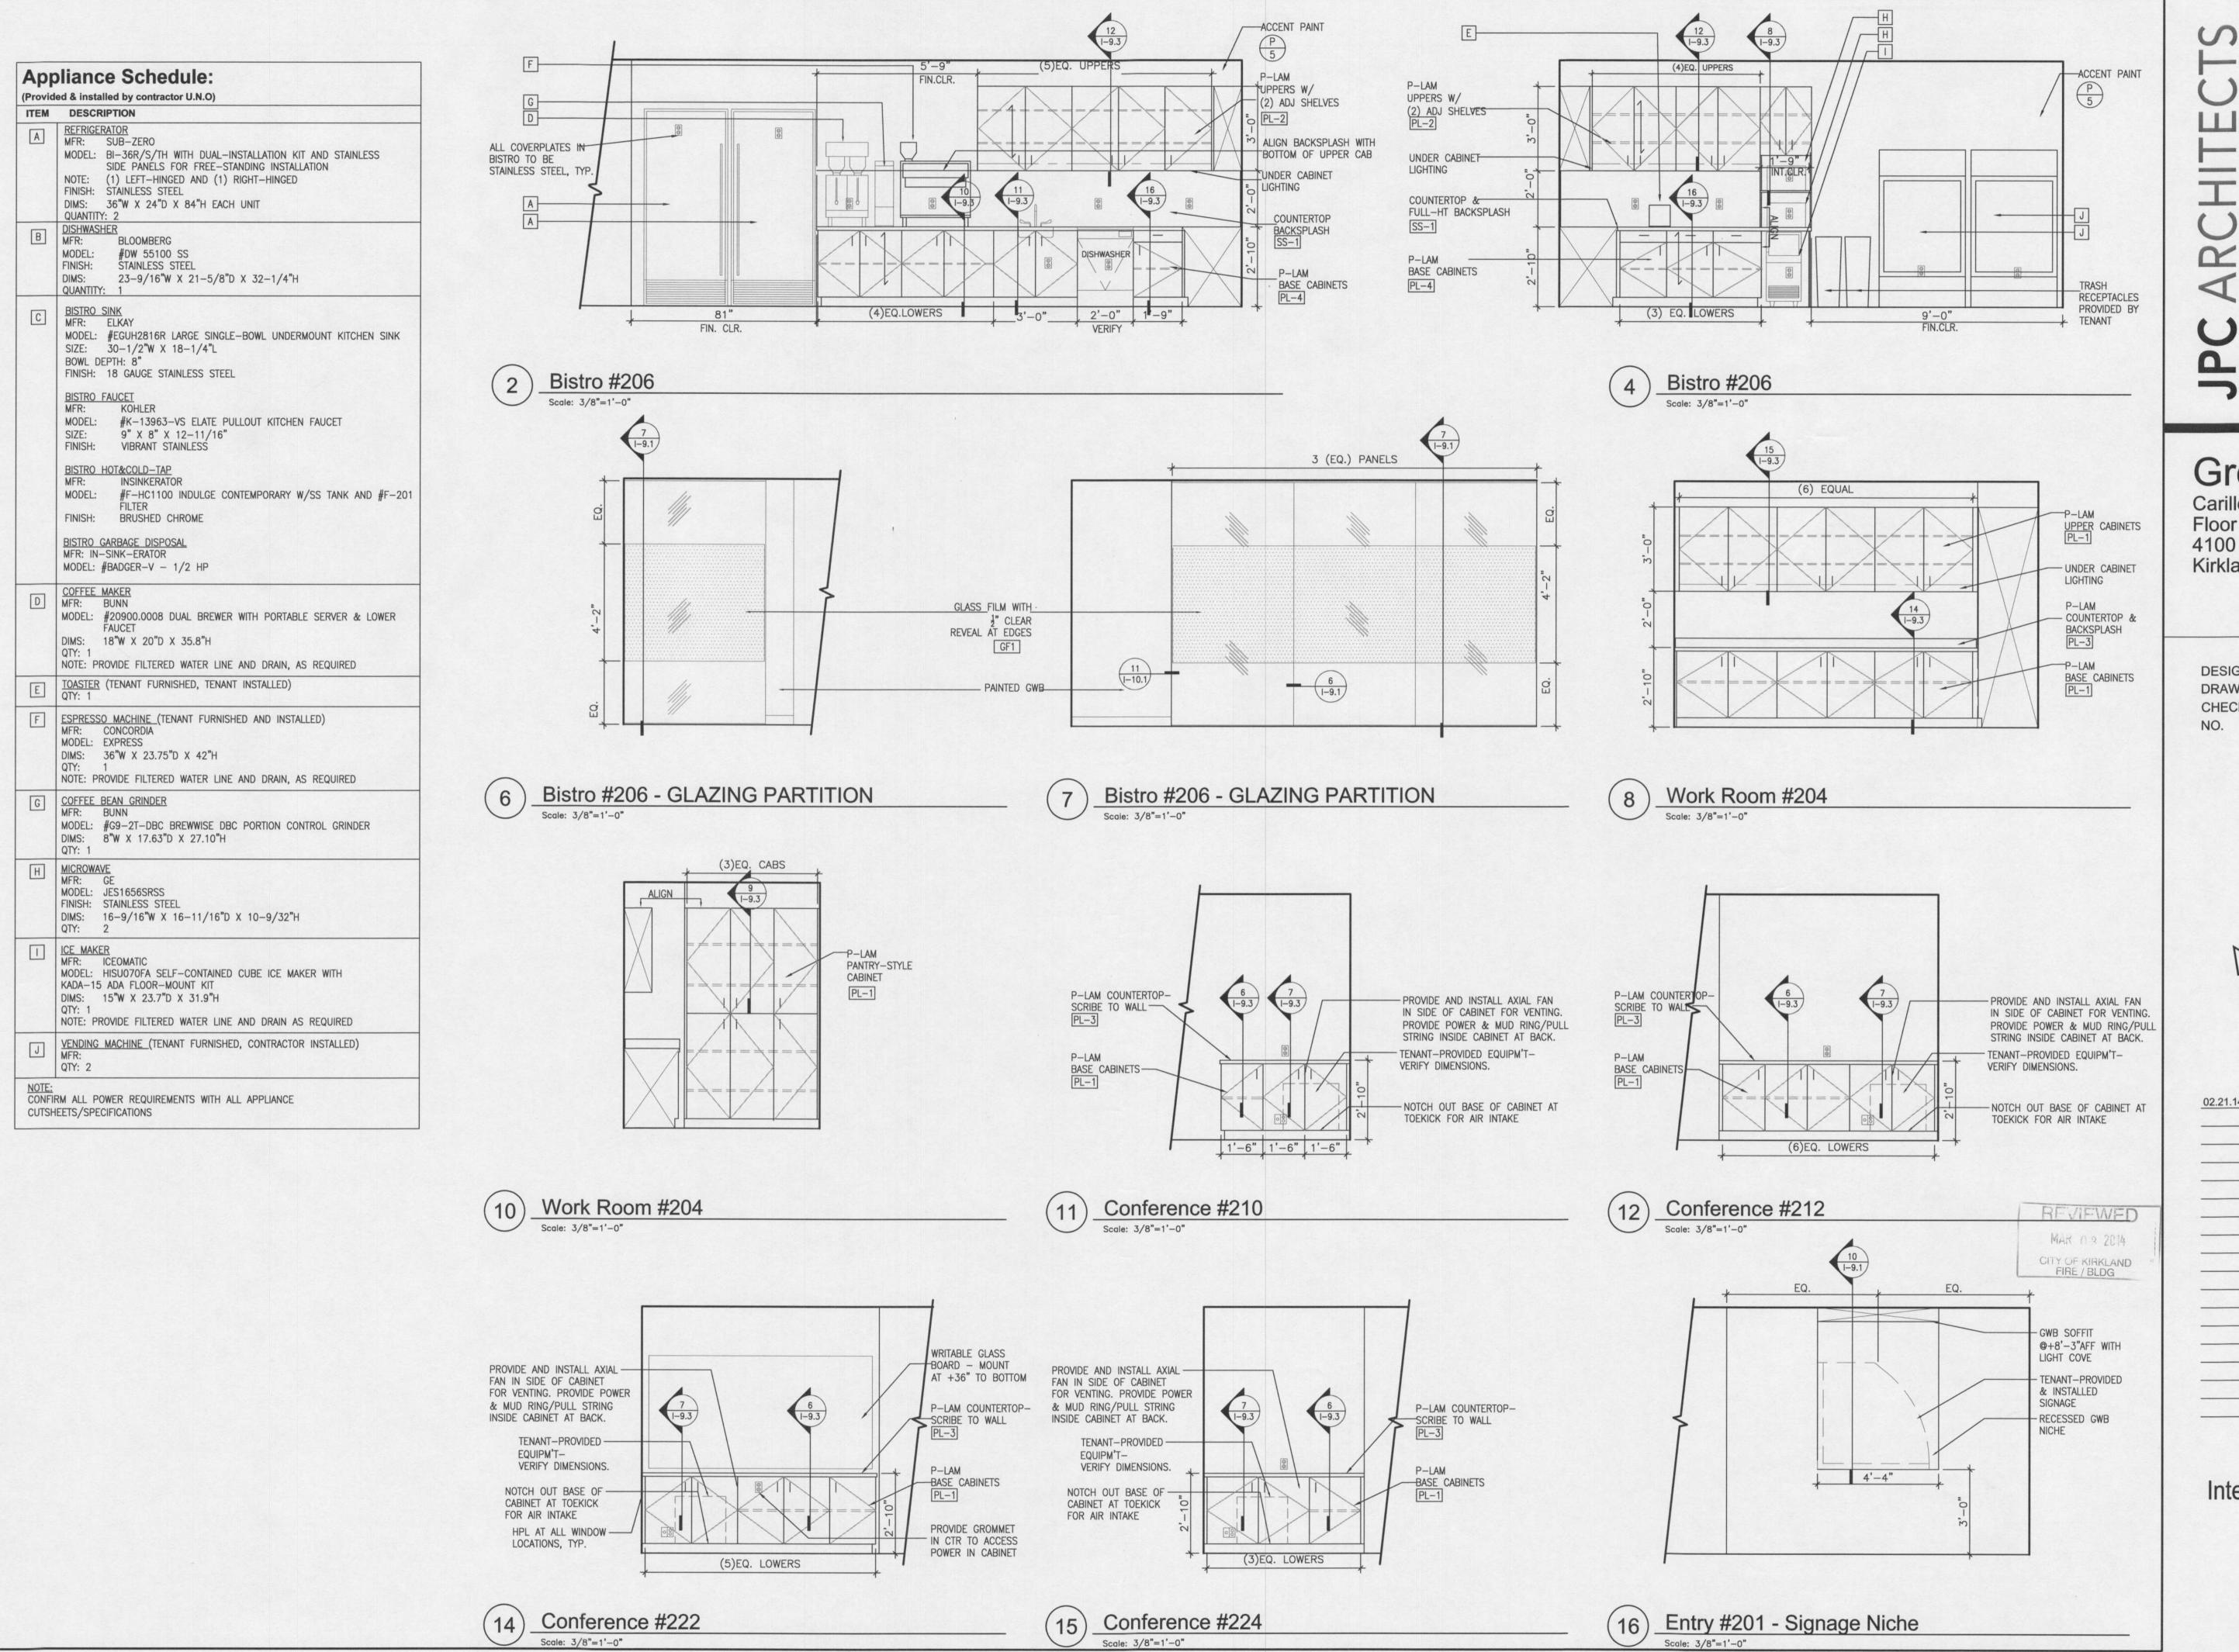

工 0

Greenpoint
Carillon Point B4000

Floor 2, Suite 4250 4100 Carillon Pt. Kirkland, WA 98033

DESIGN JPC DRAWN VA/CB CHECKED AN 13-0944

Permit/CD Issue

Interior Elevations

1-8.1

VERT 12GA HANGER WIRE @ 48"OC

AT EA JOIST & @ 2'-0" MAX FROM

EA END W/ HILTI CC27XALH-27P8T

CONN AT SLAB, TYP

SEISMIC POD W/ 12GA

SPLAY WIRE W/ HILTI

CC27XALH-27P8T, TYP

IN (4) DIRECTIONS AT ANGLE SHOWN

-250S125-30 JOIST

-087F125-27 MIN

W/ (2) #8 SCREWS TO EA JOIST, TYP

NOTE: SEISMIC POD REQUIRED @ 8'-0"OC IN EACH DIRECTION

IN GYPSUM SHEATHED CEILING [(1)LAYER]. LOCATE 48" FROM

BOXED-STUD AT

HANGER (12" LONG)

Typical Gypsum Ceiling Framing

END OF JOISTS.

POWER DRIVEN FASTENER OR APPROVED EQUAL

STRUCTURE

100LB. MINIMUM PULL

12 GA HANGER

GALVANIZED WIRE.

SPACING 4'-0" O.C.

OUT TO UNDERSIDE

HAT CHANNEL @ 16"OC

1 5/8" 20 GA METAL

4'-0" O.C. WITH (2)

- PROVIDE LATERAL

BRACING PER 5/1-9.1

CHANNEL BRACING

- 5/8" GYPSUM WALL BOARD

#8 SCREWS

Non-Bearing Non-Structural Limtiing Wall Height Tables

NON-BEARING WALL HEIGHT TABLE NOTES

1. WALL HEIGHTS ARE BASED ON ALLOWABLE DEFLECTION OF L/240.

2. WALLS ARE TO RECEIVE MINIMUM 1/2" GWB BOTH SIDES.

3. IF WALL HEIGHT FOR COMPOSITE ACTION IS USED, GWB IS TO BE FASTENED WITH MINIMUM #6 SCREW AT 12" O.C.

4. HEIGHTS ARE BASED ON THE SSMA CATALOG.

5. TABLES ARE BASED ON 5 PSF LATERAL

TABLES TO BE USED FOR NON-BEARING NON-STRUCTURAL STUD WALLS ONLY.

MATERIAL GAUGES ARE FOR REFERENCE

B. WHERE GWB DOES NOT EXTEND TO TOP OF STUDS USE LIMITING WALL HEIGHTS FOR NON COMPOSITE WALLS AND PROVIDE MECHANICAL BRACING OF STUD FLANGES PER SSMA STANDARDS.

-MAX. 1/8" GAP WITH CLEAR

- CLEAR TEMPERED GLASS

BOTTOM OF SOFFIT

GLASS SIGNAGE MOUNTED WITH

BLOCKING REQUIREMENTS

- EXISTING PARTITION

'L' BRACKETS (PROVIDED & INSTALLED

BY TENANT) - VERIFY WEIGHT &

MDF WITH TAPERED EDGES.

MUD INTO GWB, PAINT TO MATCH

SILICONE CAULK

- SHIM AS REQ'D, SECURE TO GRID INSULATION TO EXTEND 2'-0" BEYOND EACH SIDE OF WALL AS NOTED BELOW - CEILING AS SPECIFIED - PAINT REVEAL FLAT BLACK OR TAPED BLACK -INSULATION AS NOTED BELOW -ONE LAYER 5/8" GWB EACH SIDE OF WALL -MTL. STUDS - WIDTH, GA. & SPACING AS NOTED BELOW - CONT. MTL. RUNNER MECHANICALLY FASTENED TO SUB-FLOOR WITH STEEL NAILS EVERY 24" O.C. WITH AN EMBED. DEPTH OF 1/2", 3/4" MAX. AT PT SLAB - SPECIFIED BASE -FINISHED FLOOR -1/8" FOAM TAPE WALL HT. STUD SIZE STUD THICKNESS STUD SPACING WALL THICKNESS WALL CEILING UL DESIGN NO. 8'-9" 2 1/2" 18 Mils 24" O.C. 3 3/4" SB SB -

Grid Ht. Partition

Glazed Partition

STRUCTURE ---APPROX. 45 MTL STUD (GA. TO MATCH WALL STUDS) AT MAX. 8'-0" O.C. AT ALTERNATE -SUSPENDED SPECIFIED -**PARTITION**

SCHEDULED DOOR -(OPEN OR CLOSED) - WALL-MOUNTED TEL. OUTLET THERMOSTAT -LIGHT SWITCH DOTTED LINE INDICATES LOCATION OF LARGER PLATE FOR GANGED HARDWARE SET -SWITCHES AS SCHEDULED 2-3/4" BUILDING STANDARD -FERIFY W/ ₹ ELEC. OUTLET -FIRE EXTINGUISHER HARDWARE CABINET TEL. OUTLET -SCHEDULE WHEN LOCATED AT -COLUMNS, CABINET AND SIGNAGE TO BE CENTERED ON COLUMN ENCLOSURE.

> UNLESS DIRECTED BY B/S TO BE DIFFERENT

Typical Mounting Heights

Partition Bracing Detail

TYPICAL, U.N.O. NOTE: HEIGHTS ARE AS NOTE

EXISTING ACT CEILING 8'-9" -EXISTING CEILING TILES AND GRID

*SB=SOUND ATTENUATION BATTS FR=FIRE RESISTIVE

-BRACE TO STRUCTURE ABOVE

-SPECIFIED CEILING

ALUMINUM CHANNEL

-FINISHED FLOOR

MATCH EXISTING ADJACENT

CLEAR TEMPERED SAFETY GLASS

PANELS PER IBC SECTION 2406

-FIRE-RETARDENT WOOD BLOCKING

-INSULATION PER PARTITION SCHEDULE

-PAINT BACK OF REVEAL FLAT BLACK -METAL BEAD AS REQUIRED -PROVIDE FRAMING PER DETAIL 9/I-9.1

GWB Soffit/ACT Overlap Section

NO. 9 GA. LATERAL SUPPORT WIRE WITHIN 3" -OF EACH CORNER OF LIGHT FIXTURE. SPLAY WIRES AS SHOWN AND FASTEN TO BEAM OR PURLIN. MIN. OF 3 WIRE TURNS EACH. CONNECTION POINT NO. 9 GA. LATERAL SUPPORT WIRE AT -CENTER ENDS OF EA. FIXTURE. FIXTURE SUPPORT WIRE SUPPLIED BY CEILING RECESSED FLUORESCENT FIXTURE CROSS TIE MAIN STRUCTURAL


Ceiling Bracing Diagram

RUNNER 4'-0" O.C.

REVIEWED MAR 0 3 2014 CITY OF KIRKLAND FIRE / BLDG

1. LATERAL BRACING CLUSTER: (4) 12 GA. GALV SOFT-ANNEALED MILD STEEL WIRES SECURED TO MAIN RUNNER WITHIN 2" OF CROSS 'T' AND SPLAYED 90 DEGREES FROM EACH OTHER AT 45 DEGREES MAX. ABOVE HORIZONTAL. CLUSTERS PLACED 12'-0" O.C. MAX. AND 6'-0" MAX. FROM EACH WALL. WIRES SHOULD BE TAUT WITHOUT CAUSING CEILING TO LIFT.

2. SUSPENSION WIRE: 12 GA. GALV. SOFT-ANNEALED MILD STEEL WIRE ENCASED IN 1/2" DIAM. CONDUIT (FOR UPLIFT RESTRAINT); SECURE WIRE TO MAIN RUNNER WITHIN 2" OF CROSS 'T'. CONDUIT TO OCCUR AT EVERY

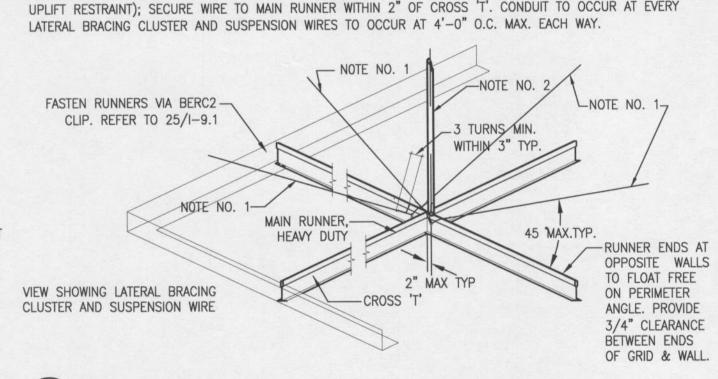

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2 1/2" 20 GA STEEL

STUDS 2'-0" O.C.

Butt Glazing Detail

STRIP LIGHT MOUNTED -

GWB Cove Light

TO BACK WALL

HANGER WIRE AT EACH -ARMSTRONG STABILIZER PERIMETER MAIN TEE BAR OR OTHER SUITABLE AND PERIMETER SYSTEM TO KEEP PERIMETER COMPONENTS FROM SPREADING APART - TYPICAL WALL MOULDING BY ARMSTRONG CEILING TYPICAL HEAVY DUTY SUSPENDED CEILING GRID SYSTEM BY ARMSTRONG

BY ARMSTRONG CEILING

Suspended Ceiling @ Perimeter Support

CROSS TEE PROVIDE CEILING EXPANSION JOINTS AS NECESSARY DIVIDING CAT. D, E & F ---CEILING INTO AREAS NO ATTACHED BERC2 GREATER THAN 2,500 S.F.

Lighting Fixture Bracing Diagram

NOTE: ACCEPTABLE ALTERNATE FRAMING METHOD PER 5/I-9.1

GWB Ceiling Diagram

Expansion Joint for Ceiling Exceeding 2500 SF

Permit/CD Issue 02.21.14

I

Greenpoint

Carillon Point B4000

Floor 2, Suite 4250

Kirkland, WA 98033

JPC

AN

VA/CB

13-0944

4100 Carillon Pt.

DESIGN

DRAWN

CHECKED

Construction Details

1-9.1



Greenpoint Carillon Point B4000

Floor 2, Suite 4250 4100 Carillon Pt. Kirkland, WA 98033

DESIGN DRAWN CHECKED NO.

VA/CB AN 13-0944

JPC

Microwave/Icemaker Cabinet @ Bistro #206

17" INT.CLR.

MICROWAVE

MICROWAVE BY G.C.

ICEMAKER BY

PROVIDE BLOCKING BEHIND CABINET AND IN WALL AS REQUIRED

3/4" ADJUSTABLE SHELF ON 2" O.C. SHELF CLIPS

MOCKETT DP55A -DRAWER PULLS IN SATIN STAINLESS

PROVIDE BLOCKING -BEHIND CABINET AND

PROVIDE DEDICATED-POWER OUTLET FOR

3/4" PLAM SHELF

COUNTERTOP

SOLID SURFACE QUARTZ -


PROVIDE PLAM PANEL AT — BACK OF OPEN CABINET

FOR ICEMAKER

MICROWAVE

IN WALL AS REQUIRED PLAM AT ALL EXPOSED EXTERIOR SURFACES


STEEL

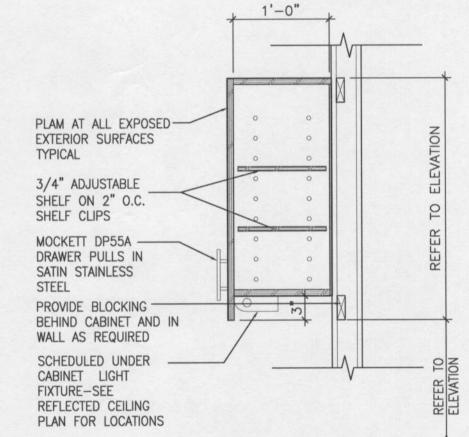

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Permit/CD Issue


Upper Cabinet with U.C. Lighting @ Bistro #206

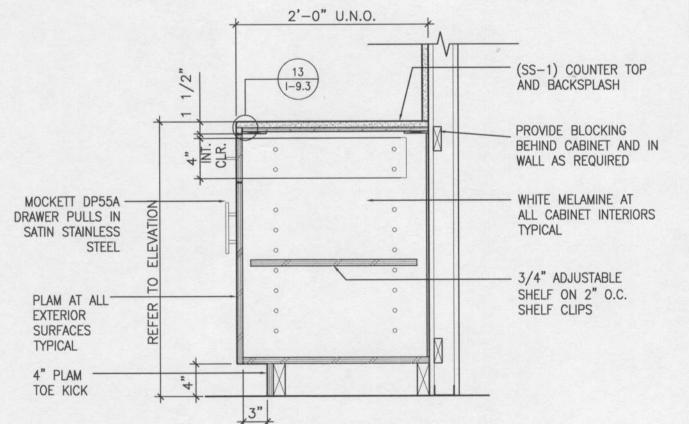

Casework Details


1-9.3

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Base Cabinet @ Conf. Rooms

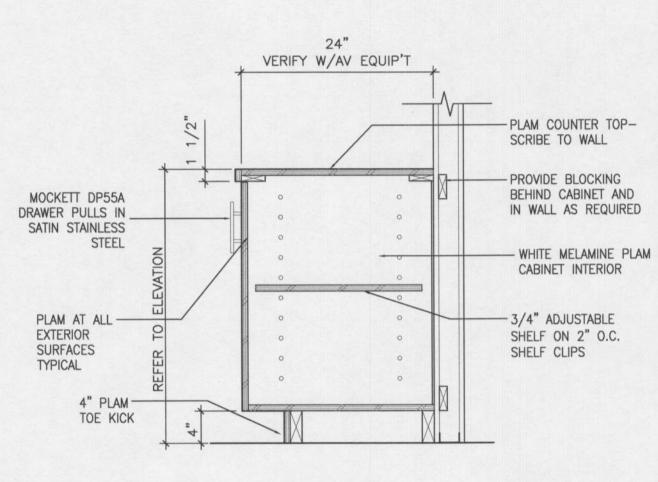Base Cabinet @ Bistro #206



Base Cabinet with Sink @ Bistro #206

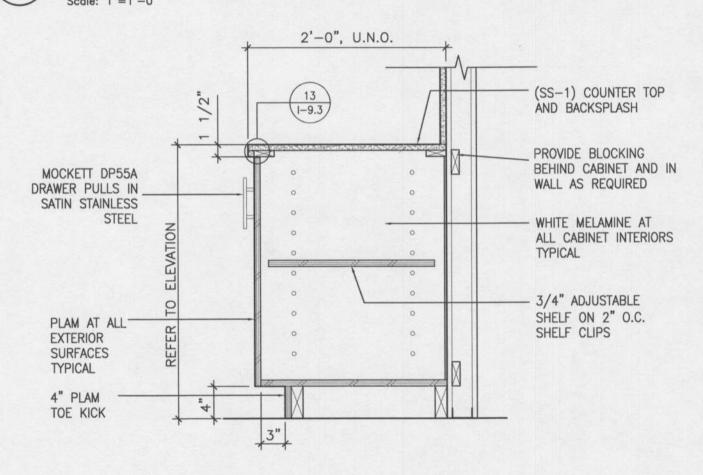MOCKETT DP55A

SATIN STAINLESS

DRAWER PULLS IN_

PLAM AT ALL EXTERIOR— SURFACES TYPICAL

MOCKETT DP55A DRAWER PULLS IN

SATIN STAINLESS

STEEL


4" PLAM -TOE KICK

4" PLAM -TOE KICK

A/V Base Cabinet @ Conf. Rooms

2'-0" U.N.O.

13 1-9.3

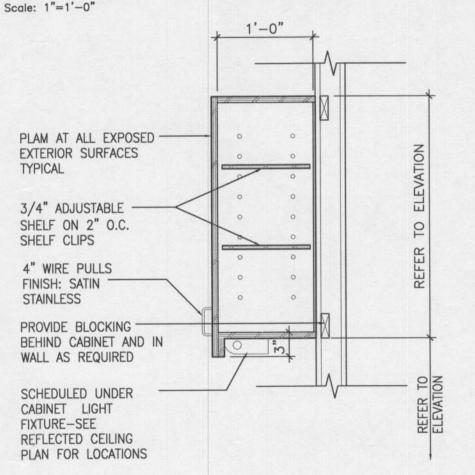

24"

VERIFY W/AV EQUIP'T

- PLAM COUNTER TOP-

PROVIDE BLOCKING

WALL AS REQUIRED

VENT AT CABINET BACK

OPEN TO WALL CAVITY

- WHITE MELAMINE PLAM

CABINET INTERIOR

FOR EXHAUST

- HIDDEN VENT AT CABINET FLOOR AS REQUIRED FOR AV COOLING

(SS-1) COUNTER TOP

AND BACKSPLASH

PROVIDE BLOCKING

STEEL SINK

DRAIN PIPING

TYPICAL

BEHIND CABINET AND

IN WALL AS REQUIRED

- UNDERMOUNT STAINLESS

-INSULATED EXPOSED

- WHITE MELAMINE AT ALL

INTERIOR SURFACES

BEHIND CABINET AND IN

SCRIBE TO WALL

-ROUND EACH CORNER OF SURFACE

26" INT.CLR.

Pantry-Style Cabinet @ Work Room #204

- PLAM COUNTER TOP AND BACKSPLASH PROVIDE BLOCKING BEHIND CABINET AND IN 4" WIRE PULLS WALL AS REQUIRED FINISH: SATIN STAINLESS WHITE MELAMINE AT PLAM AT ALL ALL CABINET INTERIORS EXTERIOR TYPICAL SURFACES TYPICAL ADJUSTABLE SHELF 4" RUBBER BASE-AT TOE KICK

2'-0" U.N.O.

Base Cabinet

Upper Cabinet with U.C. Lighting @ Work Room #204 (16).

Quartz Surfacing Edge Detail

PROVIDE BLOCKING BEHIND CABINET AND

O IN WALL AS REQUIRED

MELAMINE AT ALL

CABINET INTERIORS

(2) ADJUSTABLE

TYPICAL

SHELVES

EACH UNIT

Base Cabinet with Drawer @ Bistro #206

PLAM AT ALL EXTERIOR

4" WIRE PULLS


4" RUBBER BASE-

Scale: 1'-0"=1'-0"

AT TOE KICK

FINISH: SATIN STAINLESS

SURFACES TYPICAL

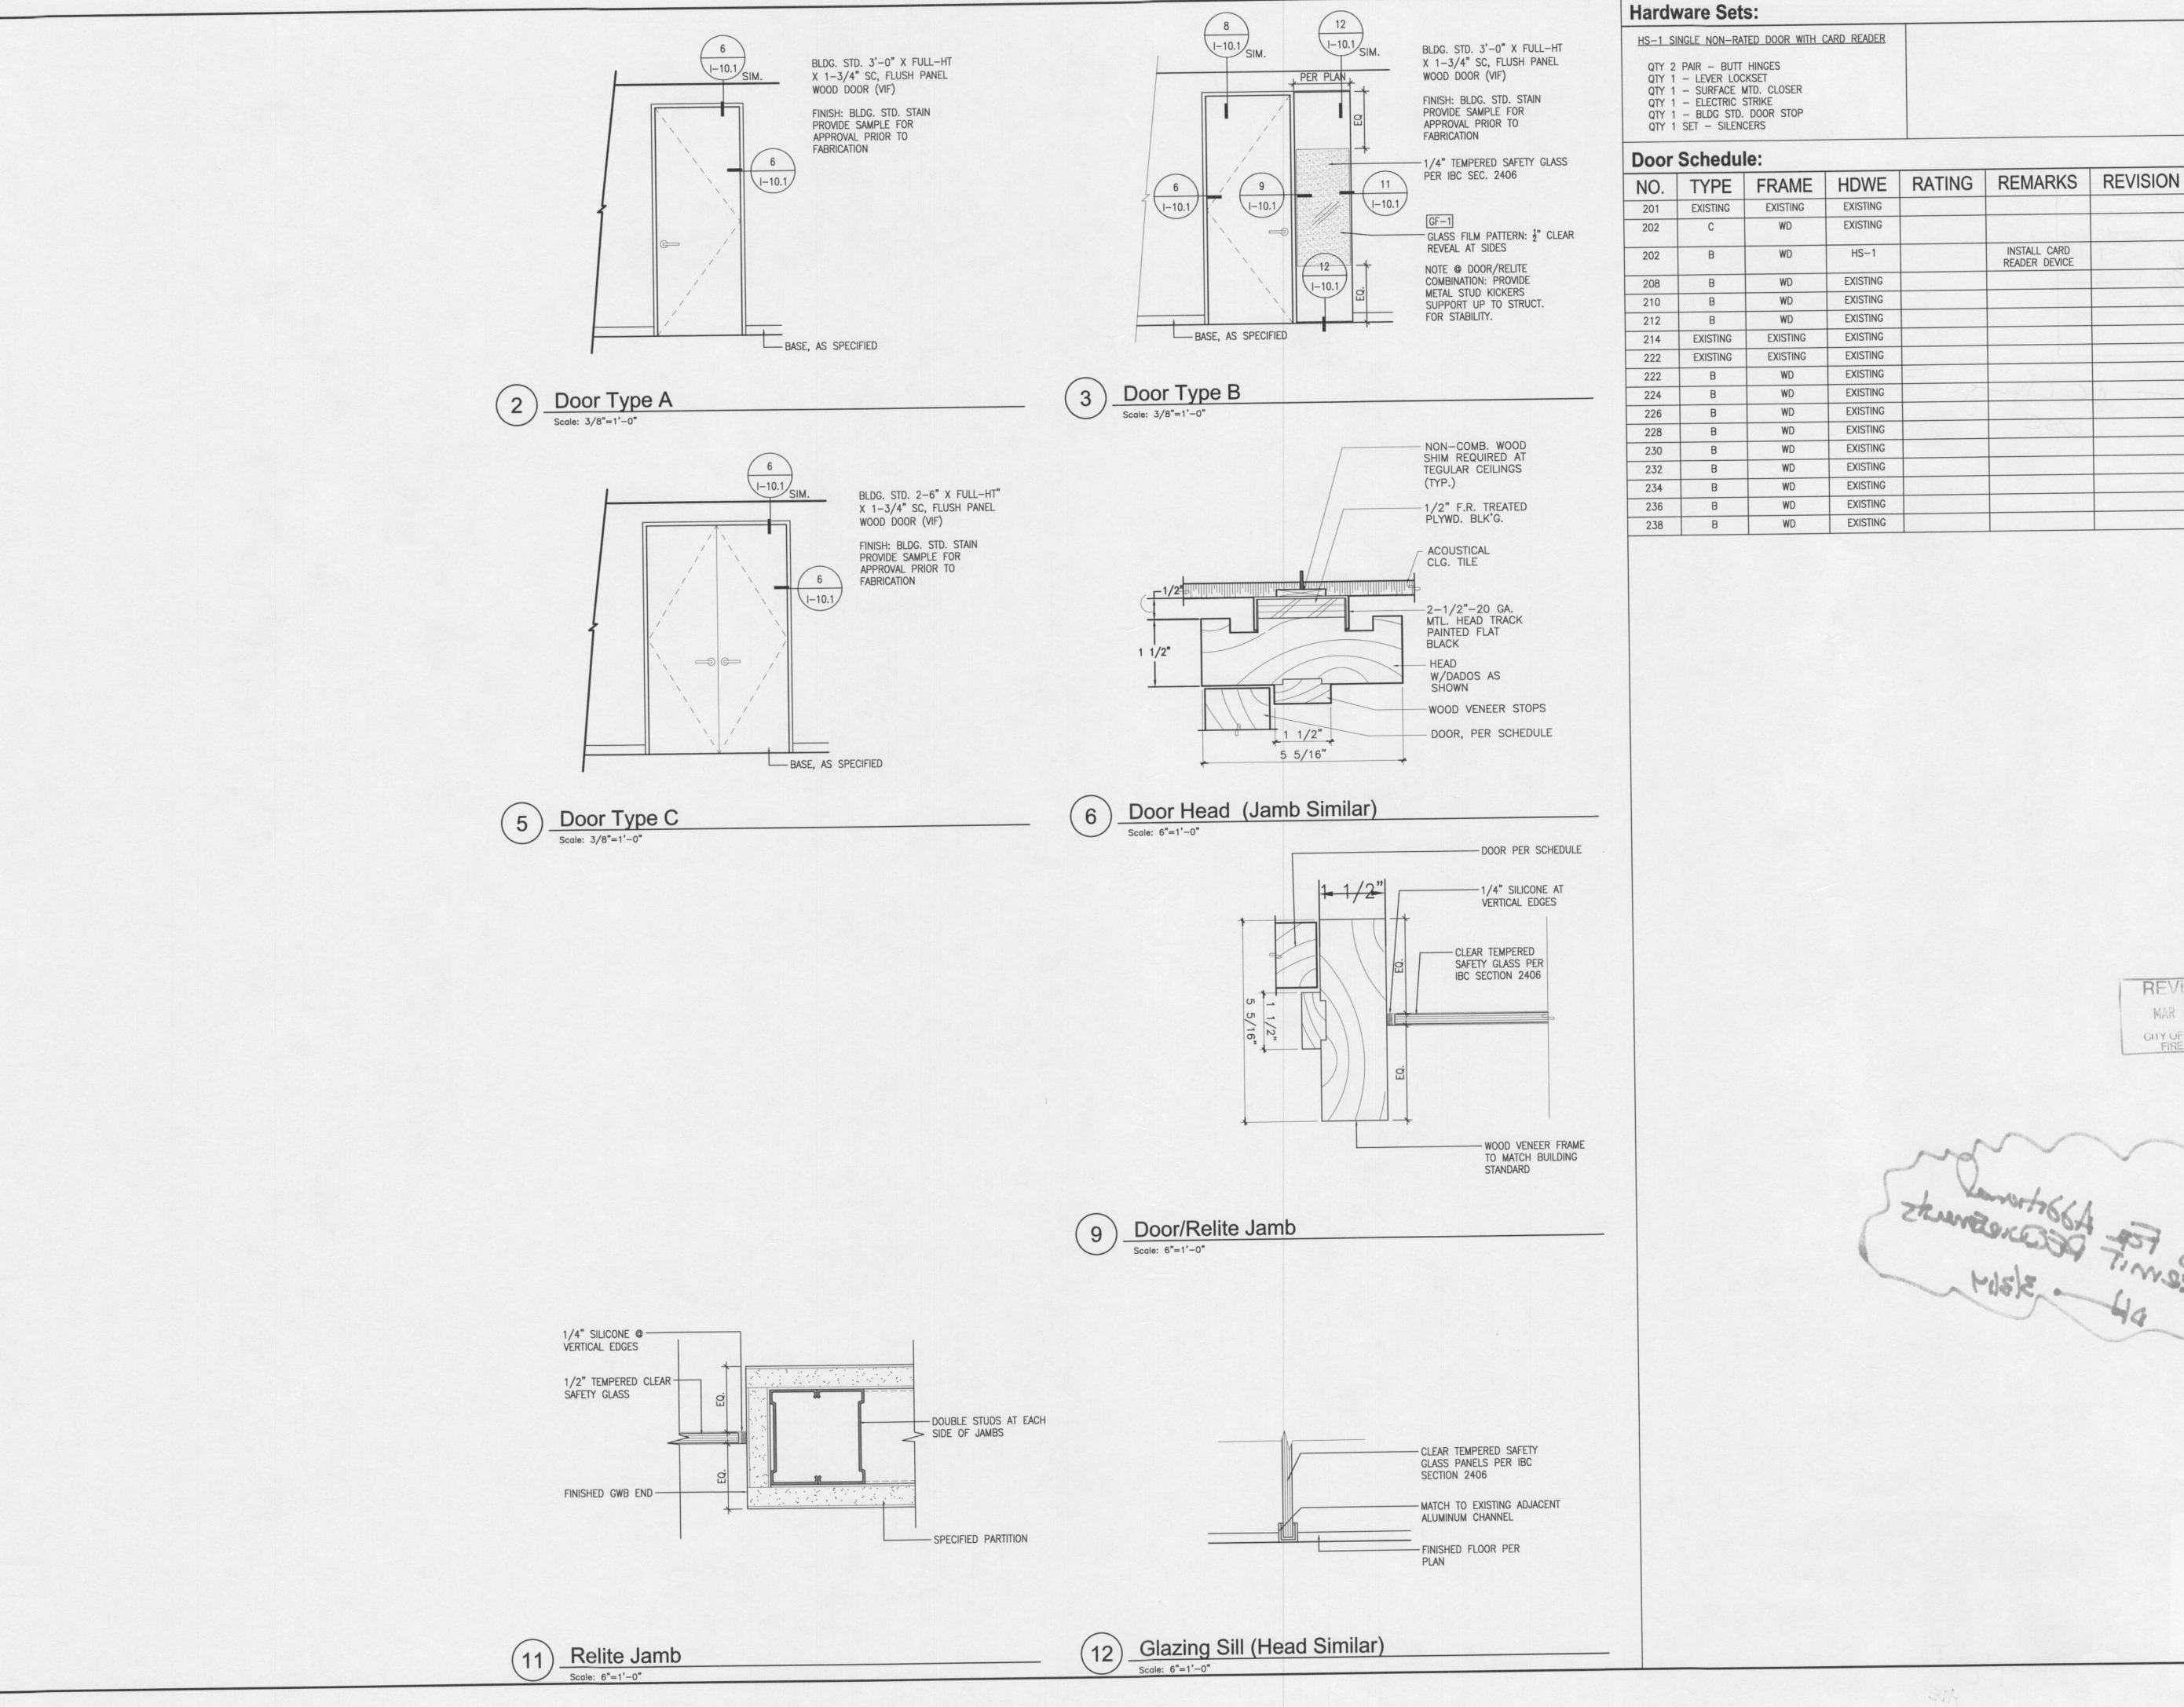

ARCHITECT

9

909 112th Avenue NE Sui Bellevue, WA 98004

Greenpoint Carillon Point B4000

Carillon Point B4000 Floor 2, Suite 4250 4100 Carillon Pt. Kirkland, WA 98033

DESIGN JPC
DRAWN VA/CB
CHECKED AN
NO. 13-0944

REVIEWED ARCHITECT


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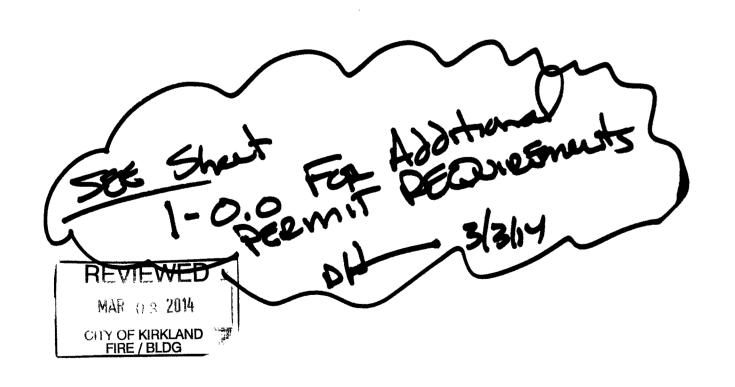
CHARLOTTE PATTERSON STATE OF WASHINGTON

Door Schedule, Elevations & Details

1-10.1



COMON :

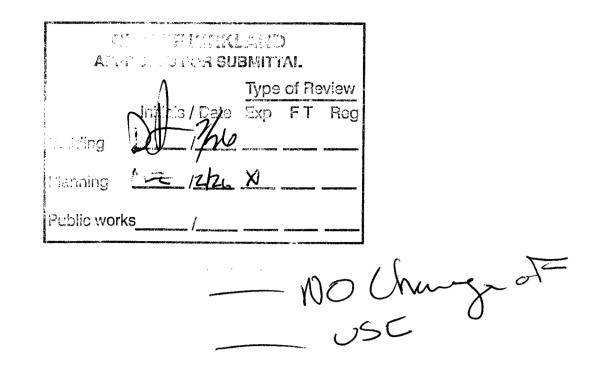

CITY OF KIRKLAND
BUILDING DEPARTMENT

PERMIT # BNR14-01032 PLAN CASE BNRP14-00348

ADDRESS 4000 CARILLON PT
WORK CLASS INTERIOR ALTERATION
PROJECT
OWNER CARILLON PROPERTIES
DT SUBMITTED 02/26/2014
DT APPROVED BY

PCD